LICENSING NOTES

- 1. J_SPY RETAINS ALL INTELLECTUAL COPYRIGHT AND DESIGN OWNERSHIP OF FREE HAUS CONCEPTS AND DRAWINGS.
- J_SPY IS OFFERING FREE LICENSING OF <u>FREE HAUS</u> DRAWINGS FOR THE USE IN CONSTRUCTING THE PROJECT FOR PERSONAL USE. NO RESALE OF J_SPY'S DRAWINGS OR IDEAS ARE PERMITTED

BUILDING NOTES

- 1. THE DRAWINGS OF FREE HAUS ARE MEANT TO PROVIDE GUIDANCE TO THE PROSPECTIVE HOME OWNER TO HELP THEM CONSTRUCT THE HOUSE OR SIMILAR VARIATION WHICH FITS THEIR SITE CONDITIONS. IT IS THE OWNER'S RESPONSIBILITY TO VERIFY ANY PERMITTING REQUIREMENTS WITH THE LOCAL JURISDICTION.
- 2. IF A LICENSED ARCHITECT IS NEEDED TO SIGN AND SEAL OR MODIFY THE DRAWINGS TO SHOW COMPLIANCE WITH LOCAL CODES, J_SPY IS WILLING TO PROVIDE THE HIRED ARCHITECT WITH OUR COMPUTER DRAWINGS WITH THE PROVISION THAT THEY SIGN AN AGREEMENT THAT THEY WILL ONLY USE OUR DRAWINGS FOR THE STATED PROJECT.
- 3. THE SIZING OF STRUCTURAL MEMBERS ARE TO BE DETERMINED BY THE CONTRACTOR OR STRUCTURAL ENGINEER. EACH SITE HAS DIFFERENT WIND LOAD, SEISMIC, OR SNOW LOAD REQUIREMENTS, AND IT IS THE OWNER'S RESPONSIBILITY TO CONFIRM THE FRAMING OF <u>FREE HAUS</u> IS SIZED APPROPRIATELY. DIMENSIONS IN J_SPY'S DRAWINGS ARE TO BE ADJUSTED AS NECESSARY.

WINDOW NOTES


1. WINDOWS ARE AN IMPORTANT ELEMENT OF A HOUSE DESIGN. WHEN DESIGNING FREE HAUS, J_SPY CONSIDERED THE CAPABILITIES OF COMMON WINDOW MANUFACTURERS IN THE USA INCLUDING; ANDERSON, PELLA, AND MARVIN WINDOWS. THE MAXIMUM STANDARD WINDOW HEIGHT FOR THESE COMPANIES IS APPROXIMATELY 8'-0", SO THE DESIGN OF FREE HAUS LIMITED THE WINDOW HEIGHT TO THIS DIMENSION. IN MOST OF J_SPY'S PROJECTS WE USE ALUMINUM WINDOWS WHICH TEND TO HAVE THE CAPABILITY OF LARGER DIMENSIONS. THESE COMPANIES ARE LESS WIDELY KNOW, SO SOME COMPANIES TO RESEARCH ARE; YAWAL, FLEETWOOD, OTTIMA, AND KLAR. ALSO KEEP IN MIND THAT FIXED WINDOWS ARE MUCH MORE AFFORDABLE THAN OPERABLE WINDOWS. J_SPY RECOMMENDS KEEPING AS MANY WINDOWS FIXED AS POSSIBLE TO KEEP THE COST DOWN. ALSO KEEP IN MIND THAT BEDROOMS REQUIRE AN OPERABLE EGRESS WINDOW.


FINISHES NOTES


- 1. THE DESIGN OF <u>FREE HAUS</u> RECOMMENDS THE CEILING FINISH BE BIRCH PLYWOOD WITH A CLEAR POLYURETHANE SEAL. IT IS IMPORTANT THAT THE NATURAL LIGHT FROM THE ROOF WINDOWS REFLECT OFF A NATURAL WOOD MATERIAL TO WARM THE COLOR OF THE LIGHT. FURTHER, SHEETROCK DOES NOT AGE WELL AND IT IS BEST TO USE MORE DURABLE MATERIALS WHEN EVER POSSIBLE.
- 2. FOR THE FLOOR, WE SHOW A WOOD FLOORING OVER A CONCRETE SLAB IN MOST OF THE HOUSE, WITH TILE IN THE BATHROOM. ANOTHER OPTION IS TO SET THE CONCRETE SLAB AS THE FINISHED FLOOR AND POLISH THE SLAB.
- 3. FOR THE SIDING, WE CAN ENVISION THE FINISH BEING A VARIETY OF MATERIALS, FROM NATURAL WOOD, BRICKS, METAL, TO STUCCO. THE SITE OF THE HOUSE SHOULD PLAY A MAJOR FACTOR IN DETERMINING WHAT MATERIAL IS MOST APPROPRIATE.

CONTACTING J_SPY

- 1. IF YOU ARE REQUIRED TO HIRE AN ARCHITECT TO SHOW COMPLIANCE WITH LOCAL CODES, YOU MAY CONTACT J_SPY AND PUT US IN TOUCH WITH YOUR ARCHITECT. WE CAN GIVE YOUR ARCHITECT OUR COMPUTER DRAWINGS SO THEY CAN BE ADJUSTED TO SHOW LOCAL COMPLIANCE. PLEASE USE OUR GENERAL EMAIL INFO@JSPYARCHITECTURE.COM
- 2. IF YOU HAVE PHOTOS OF CONSTRUCTION PROGRESS OR A COMPLETED HOUSE, PLEASE SEND THEM TO US AT INFO@JSPYARCHITECTURE.COM

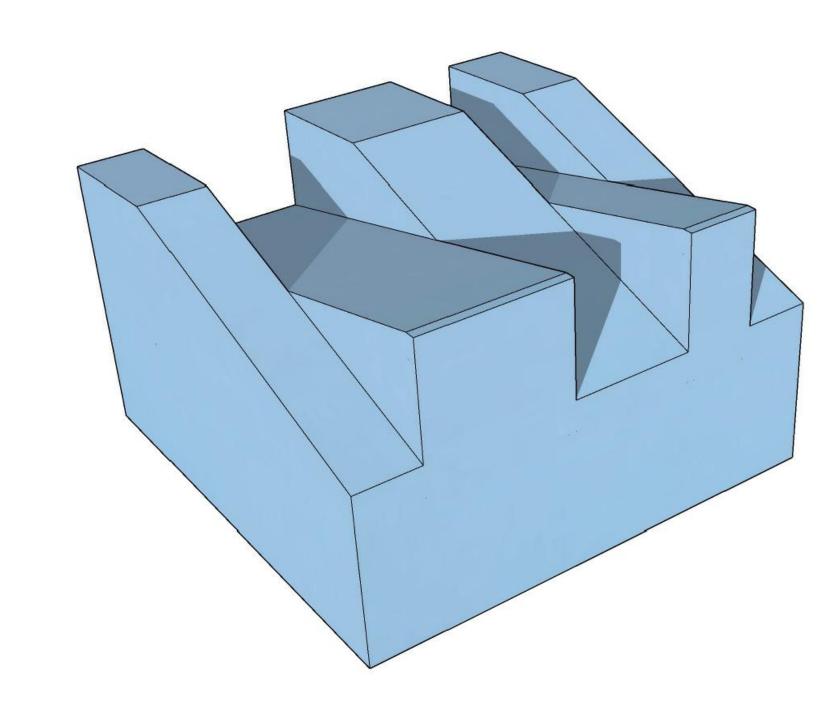

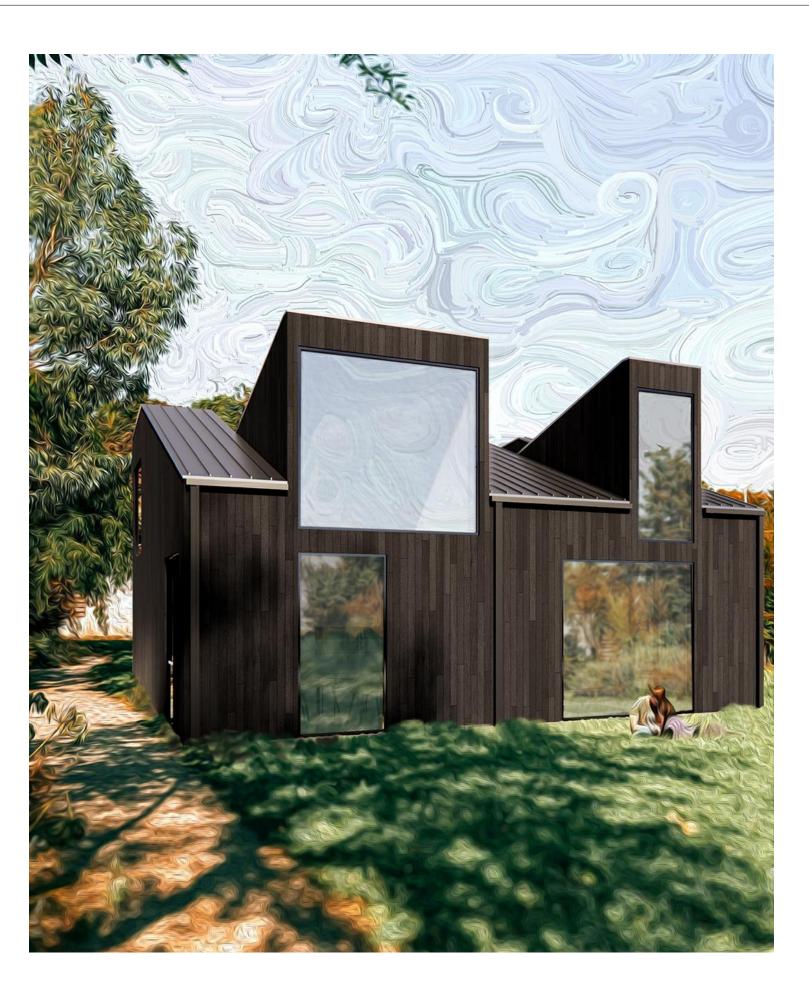

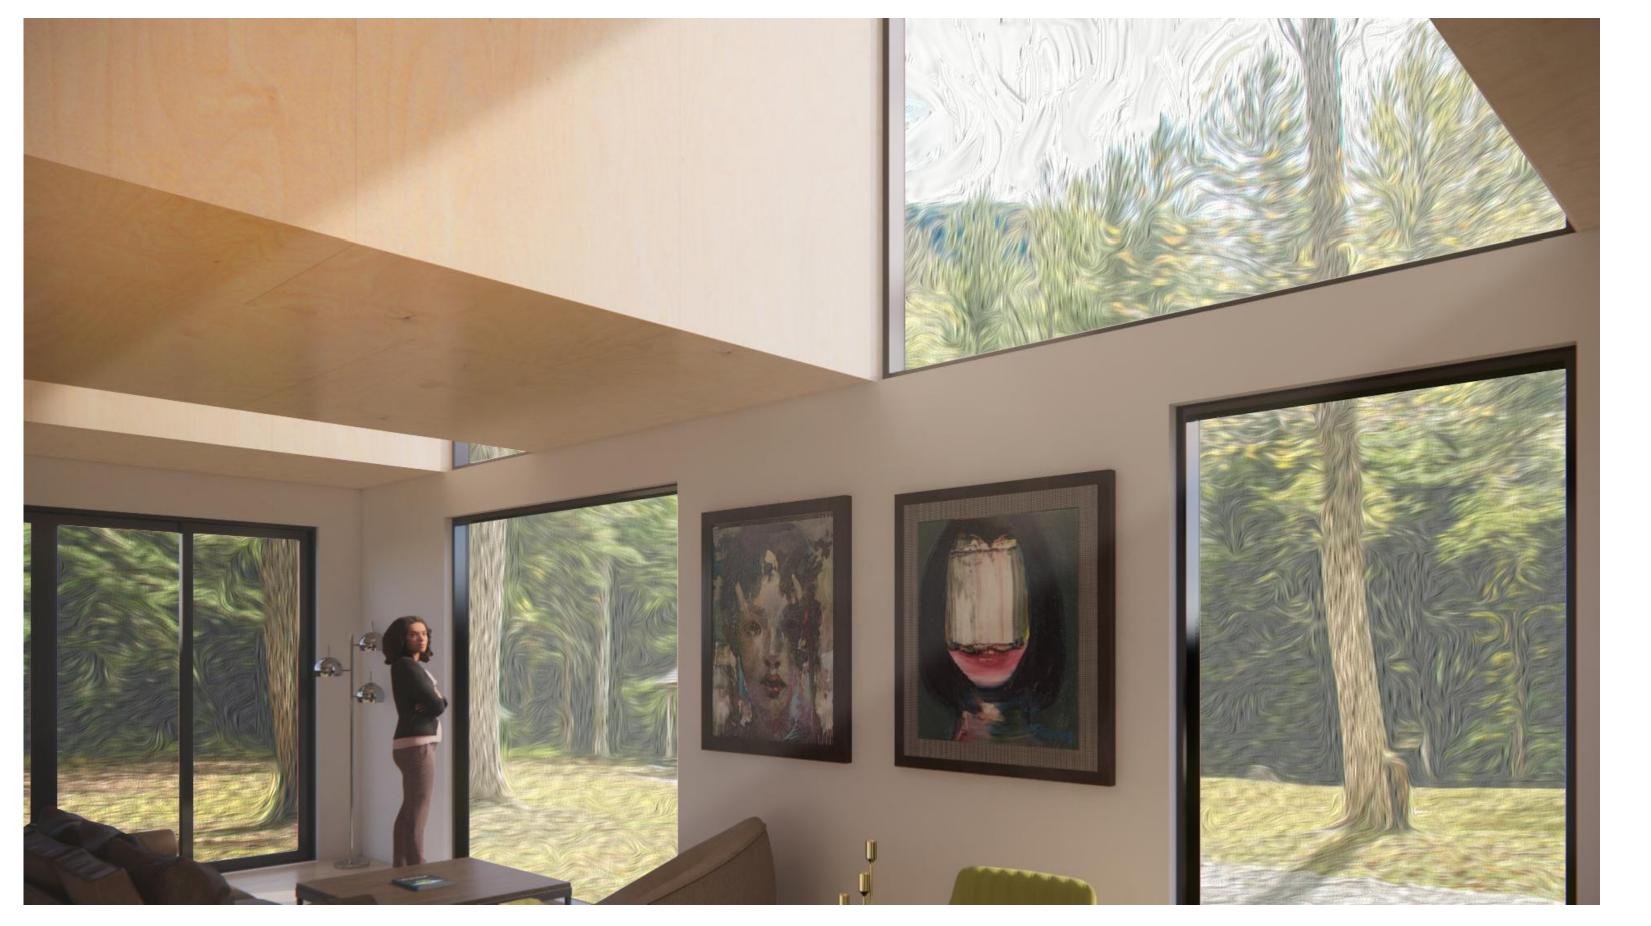

FREE HAUS

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DRAWING LIST

G.100 COVER SHEET FOUNDATION PLAN A.100 GROUND FLOOR PLAN FRAMING PLAN LOWER ROOF A.102 FRAMING PLAN UPPER ROOF A.103 A.104 **ROOF PLAN** ROOF FRAMING DIAGRAMS RCP ELECTRICAL PLAN EXTERIOR ELEVATIONS A.201 BUILDING SECTION A.202 BUILDING SECTION BUILDING SECTION A.203 A.204 **BUILDING SECTION** A.205 BUILDING SECTION INTERIOR ELEVATIONS


A.800 MECHANICAL DIAGRAM

DESIGN ARCHITECT J_SPY ARCHITECTURE AND DESIGN

DATE: MARCH 7, 2024 SCALE:

SHEET TITLE: **COVER SHEET**

DISCLAIMER:
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DESIGN ARCHITECT
J_SPY ARCHITECTURE AND DESIGN

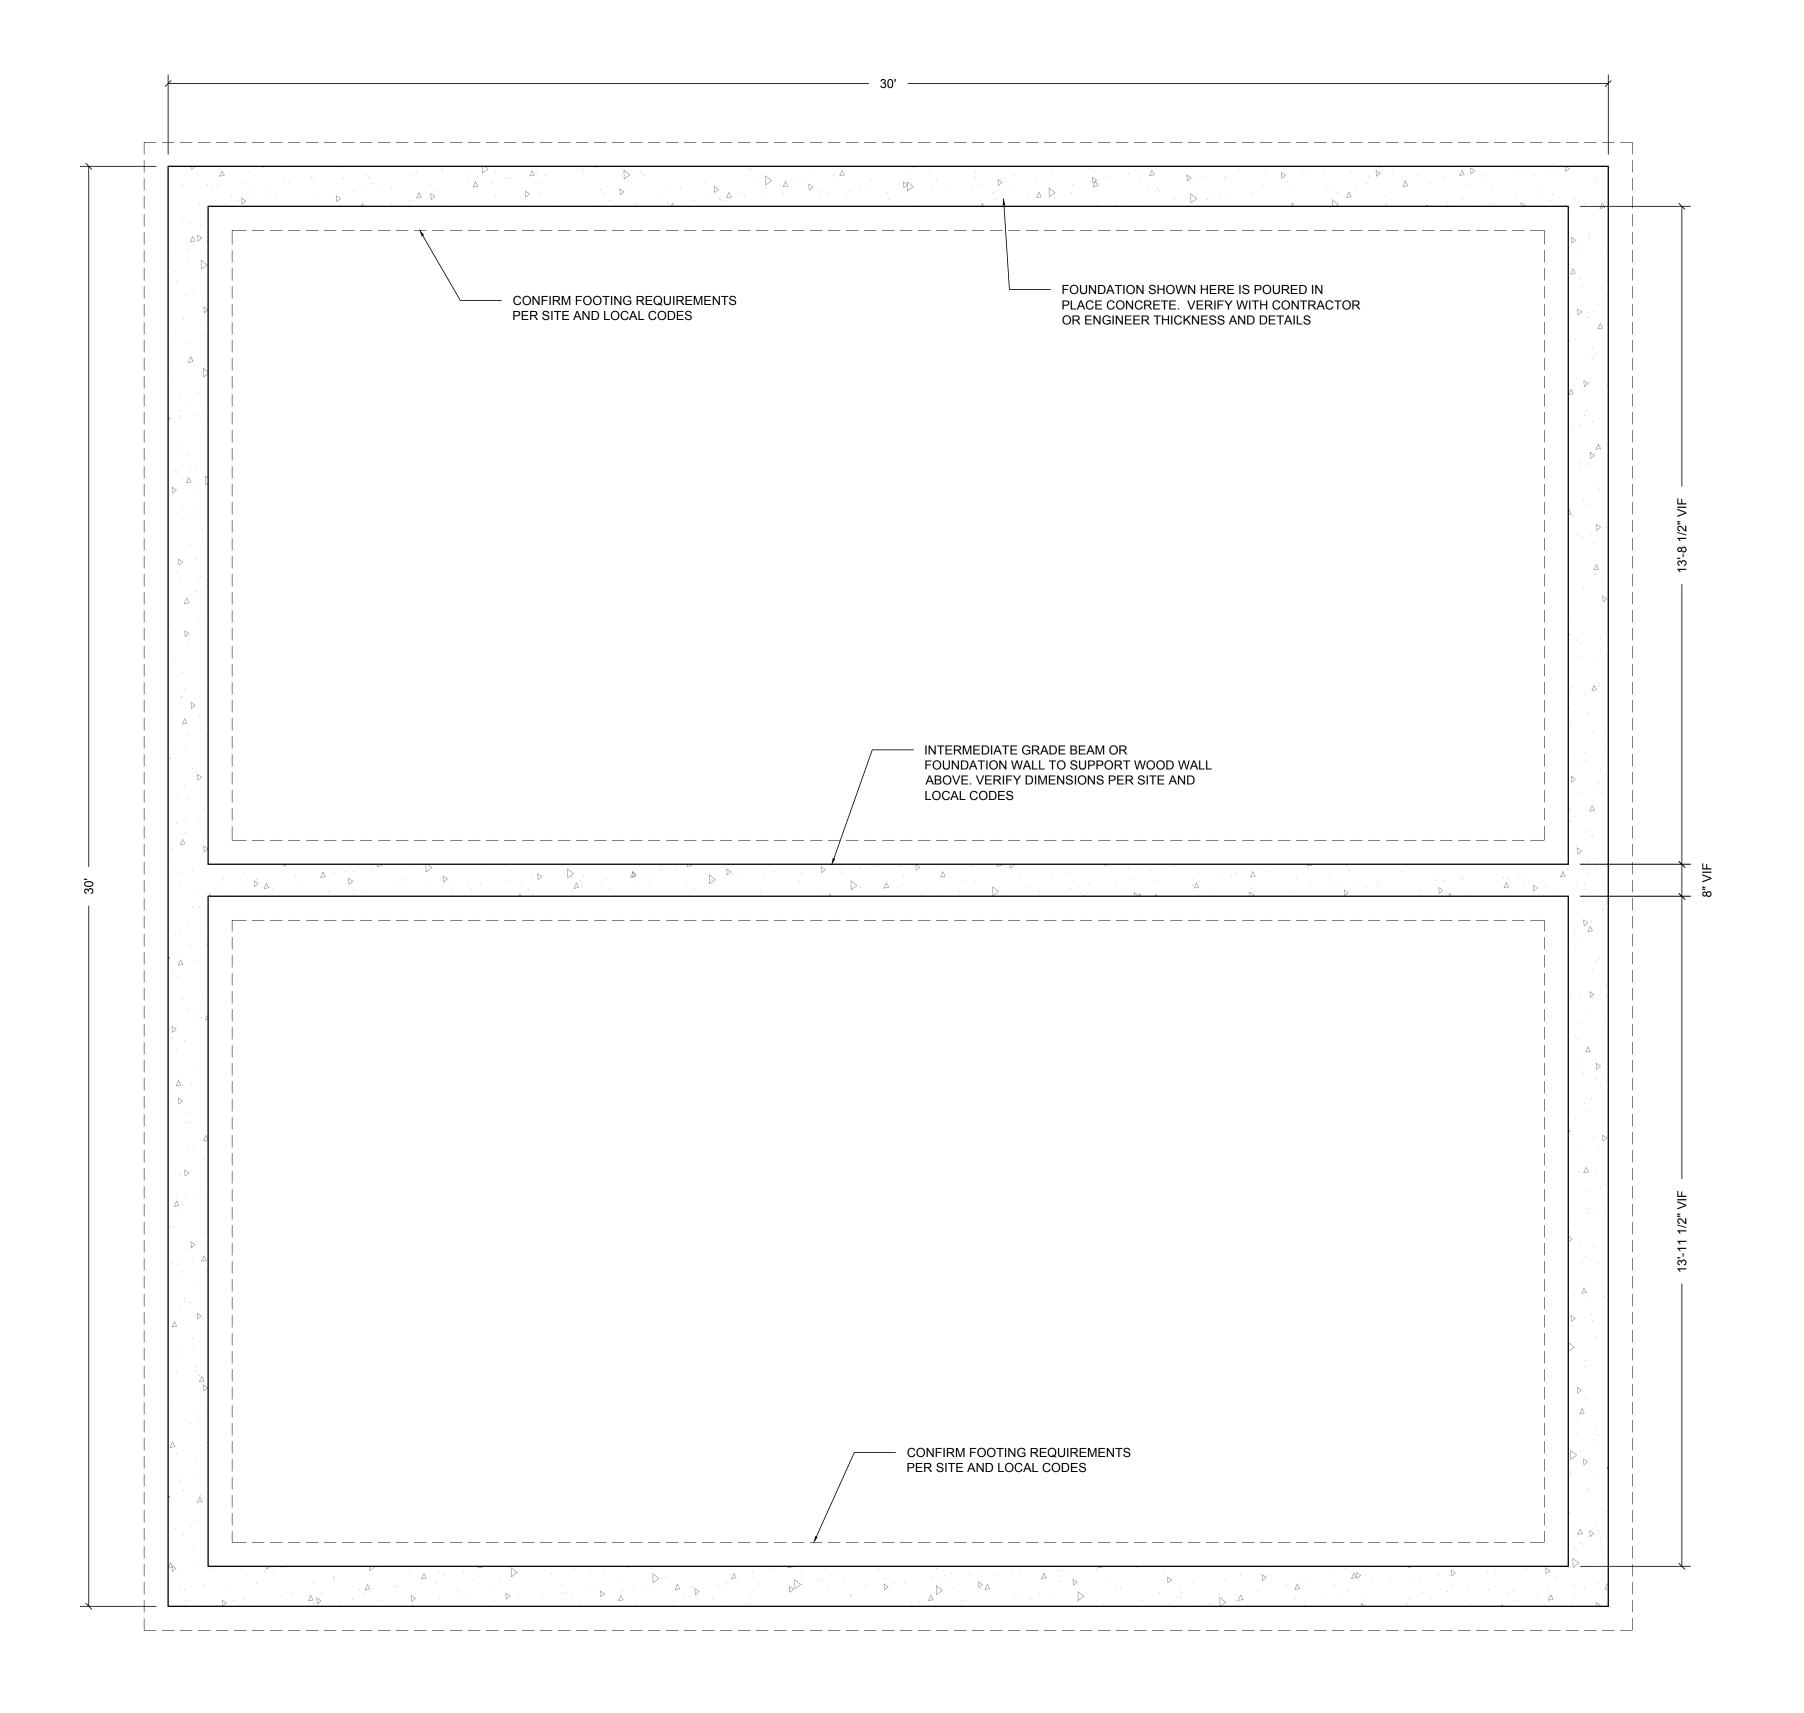
DATE: MARCH 7, 2024

SCALE: 1/2" = 1'-0" SHEET TITLE:

FOUNDATION PLAN

A.100

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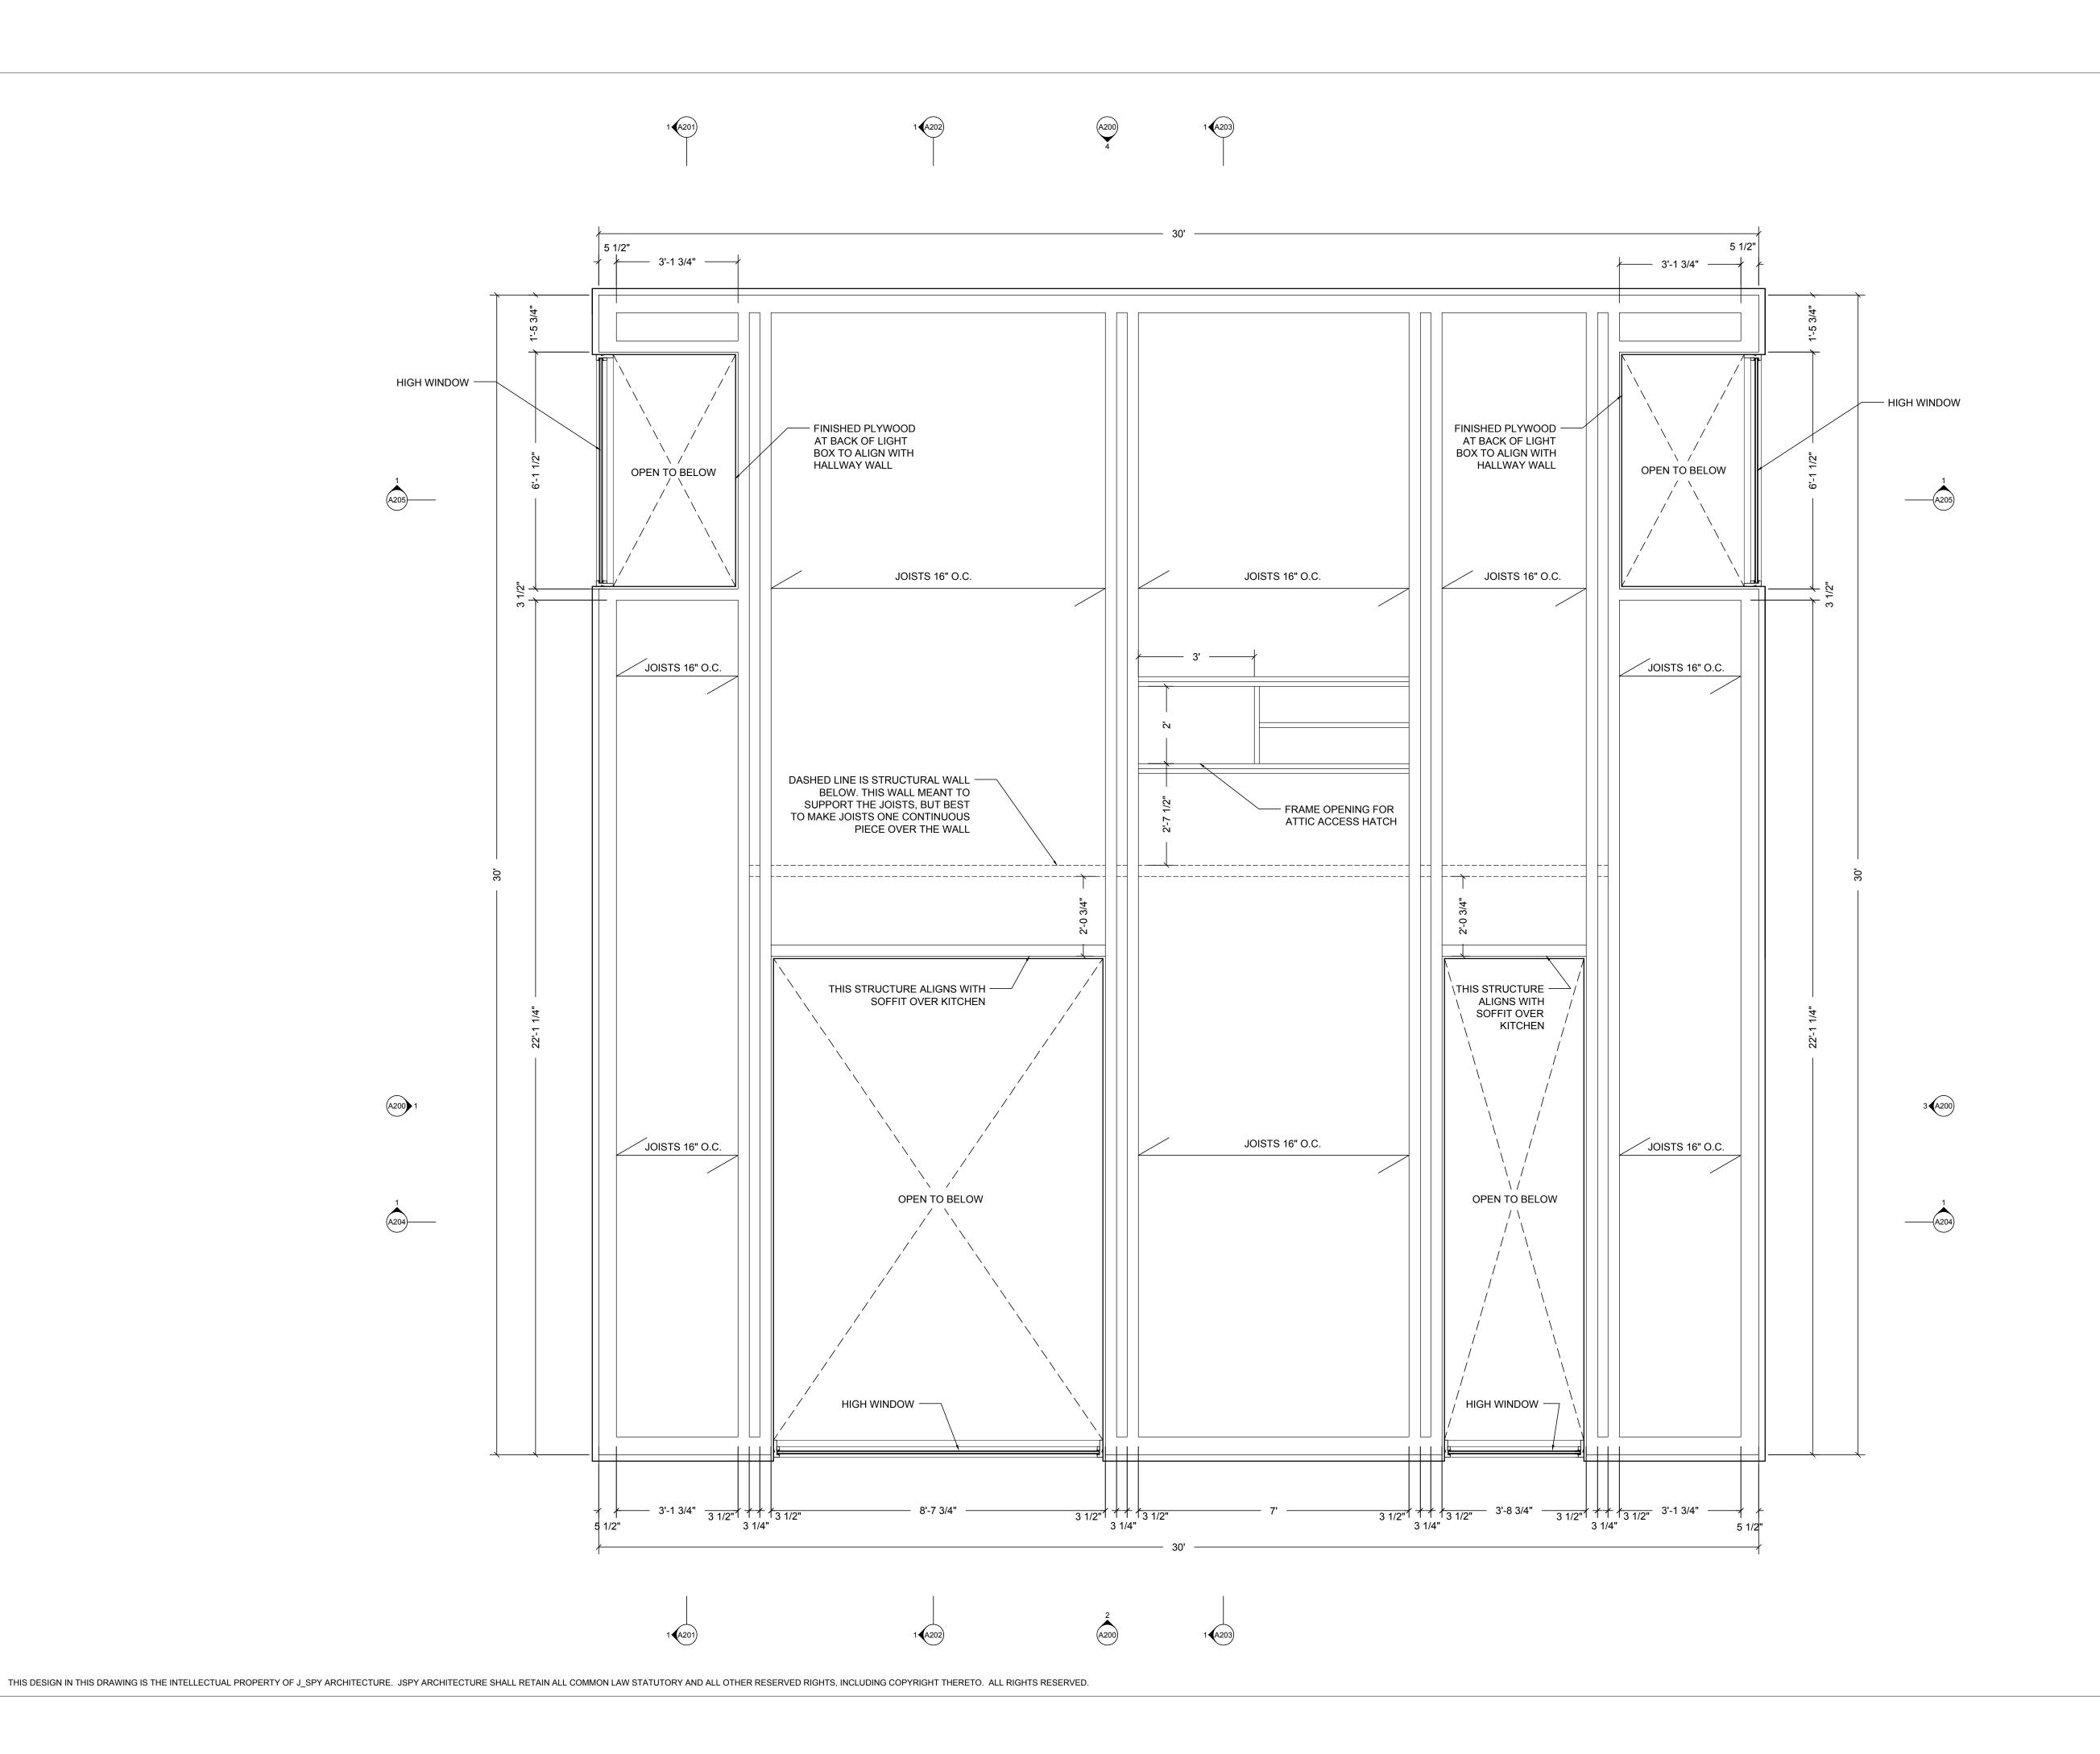
DESIGN ARCHITECT
J_SPY ARCHITECTURE AND DESIGN

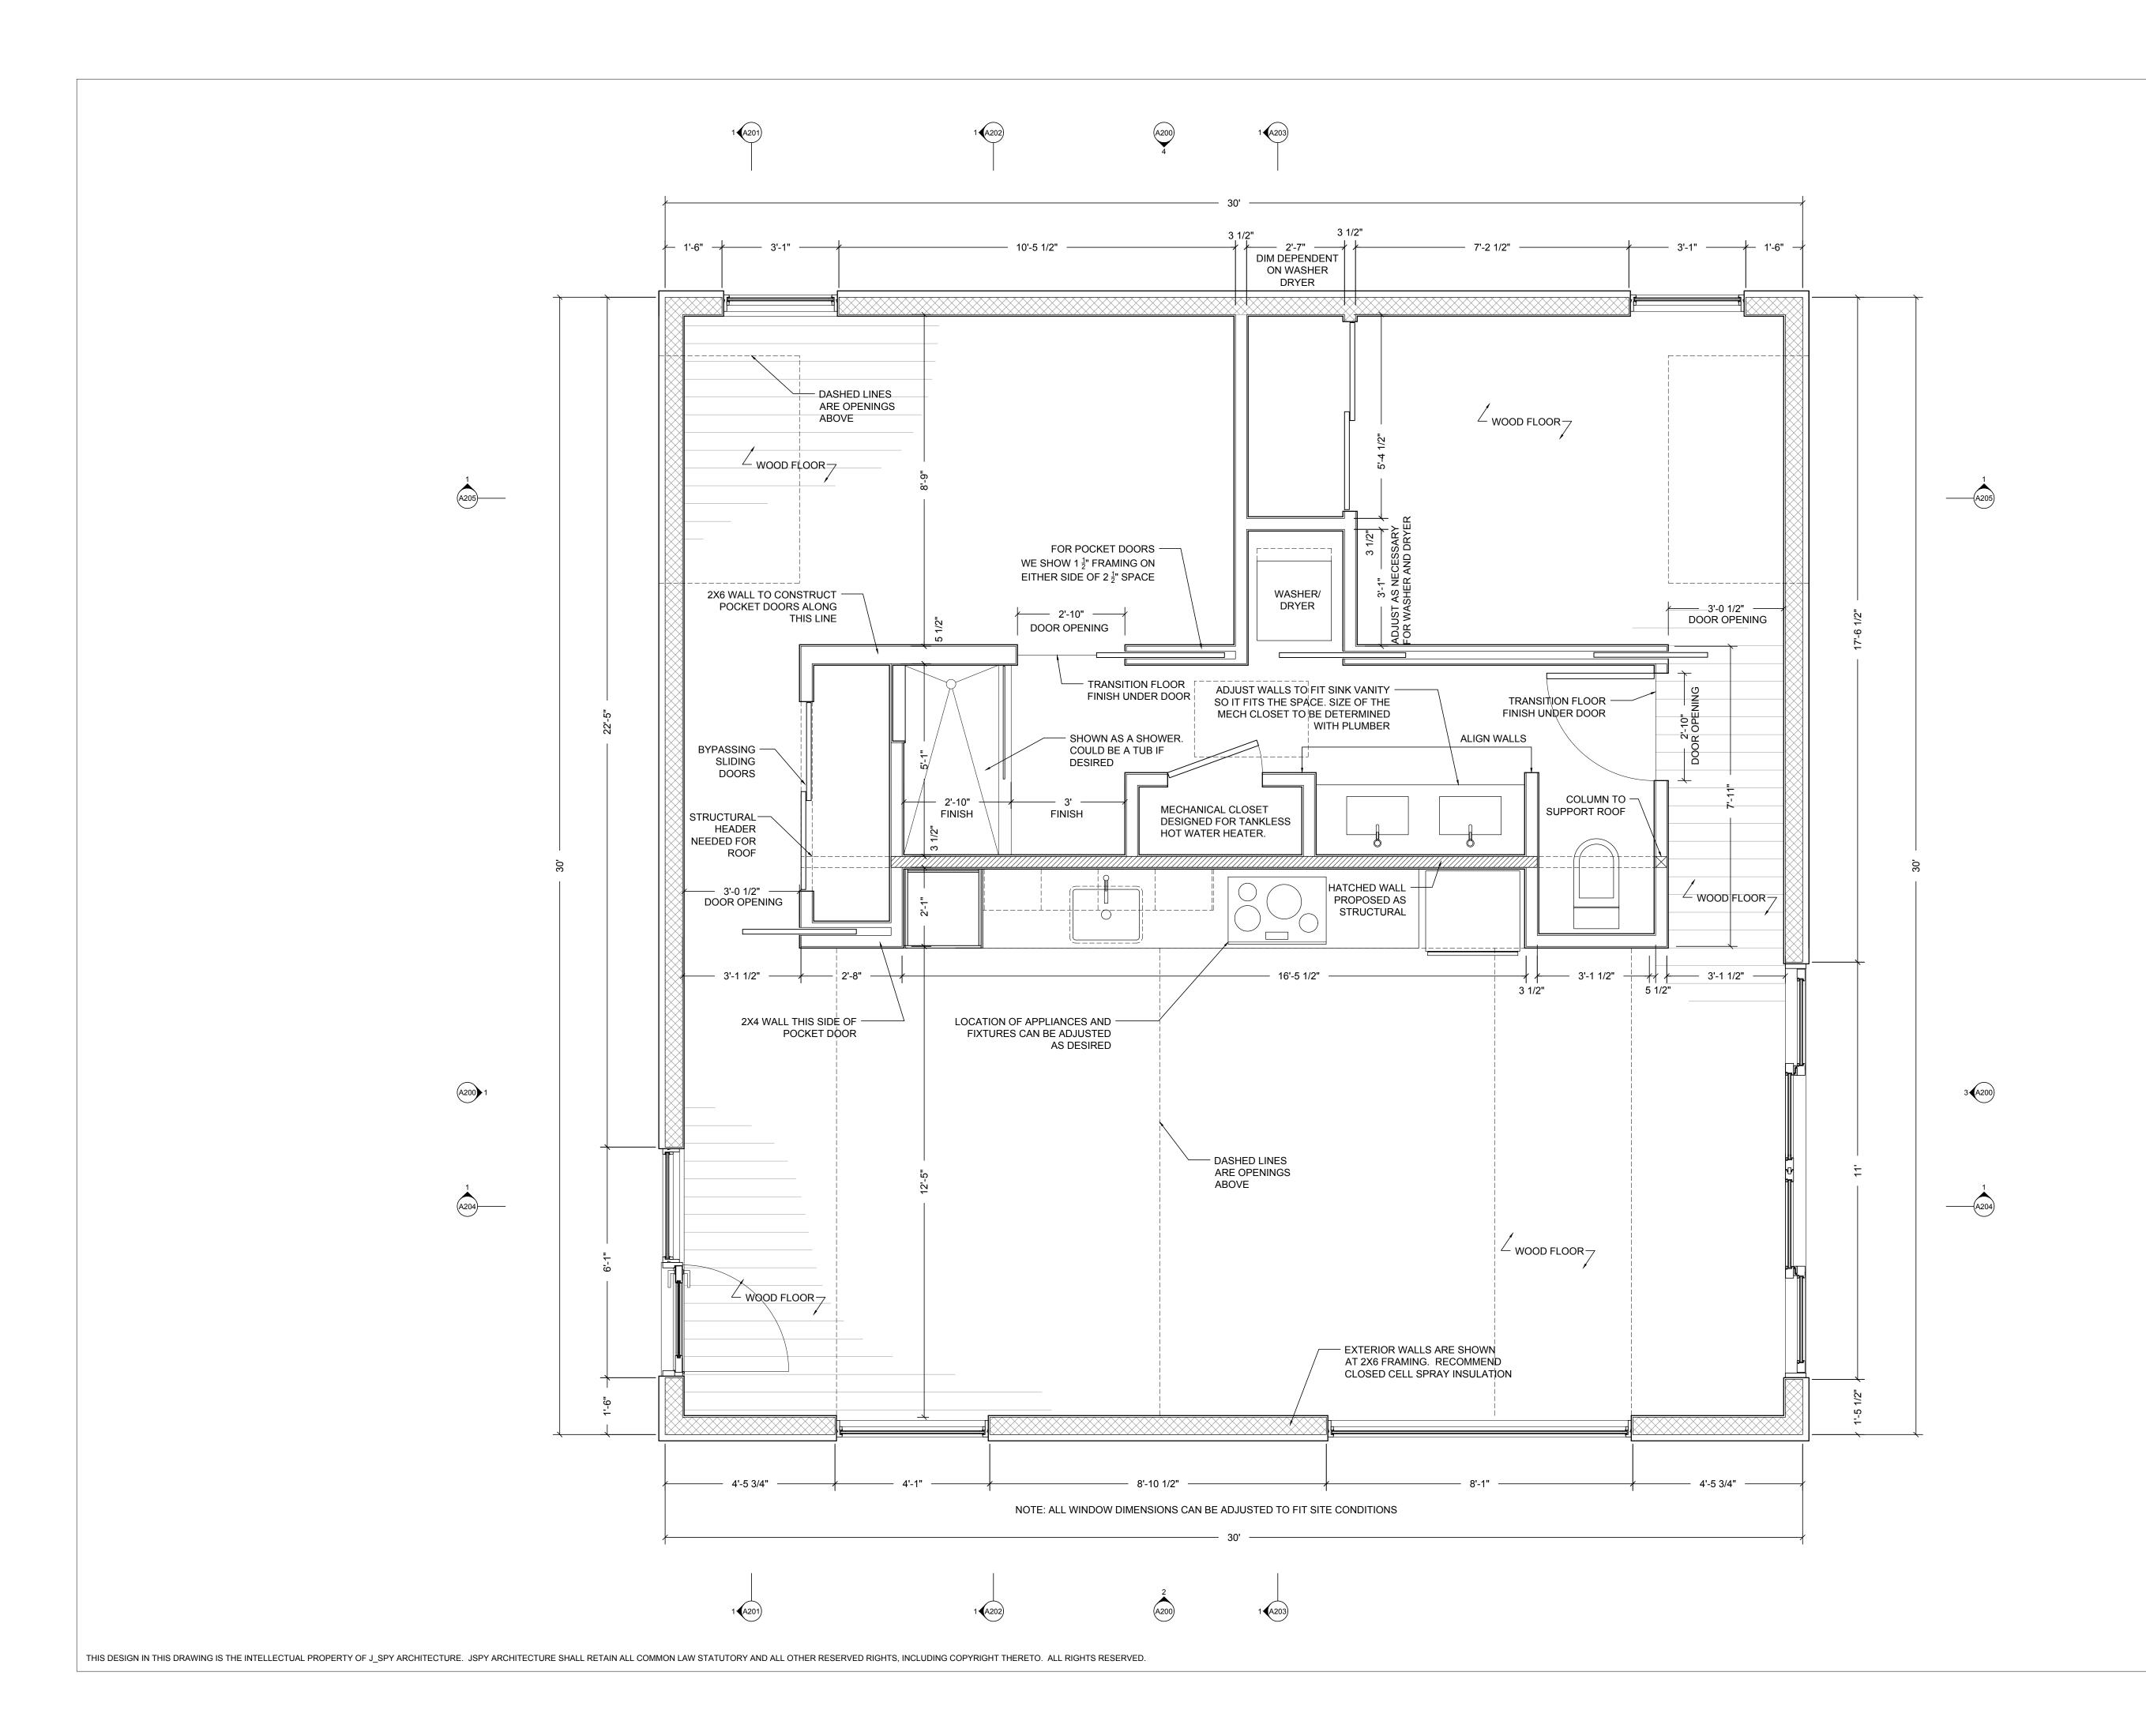DATE: MARCH 7, 2024

SCALE: 1/2" = 1'-0"

SCALE: 1/2" = 1'-0"
SHEET TITLE:

GROUND FLOOR PLAN




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DESIGN ARCHITECT
J_SPY ARCHITECTURE AND DESIGN

DATE: MARCH 7, 2024

SCALE: 1/2" = 1'-0"

SHEET TITLE:
FRAMING PLAN
LOWER ROOF

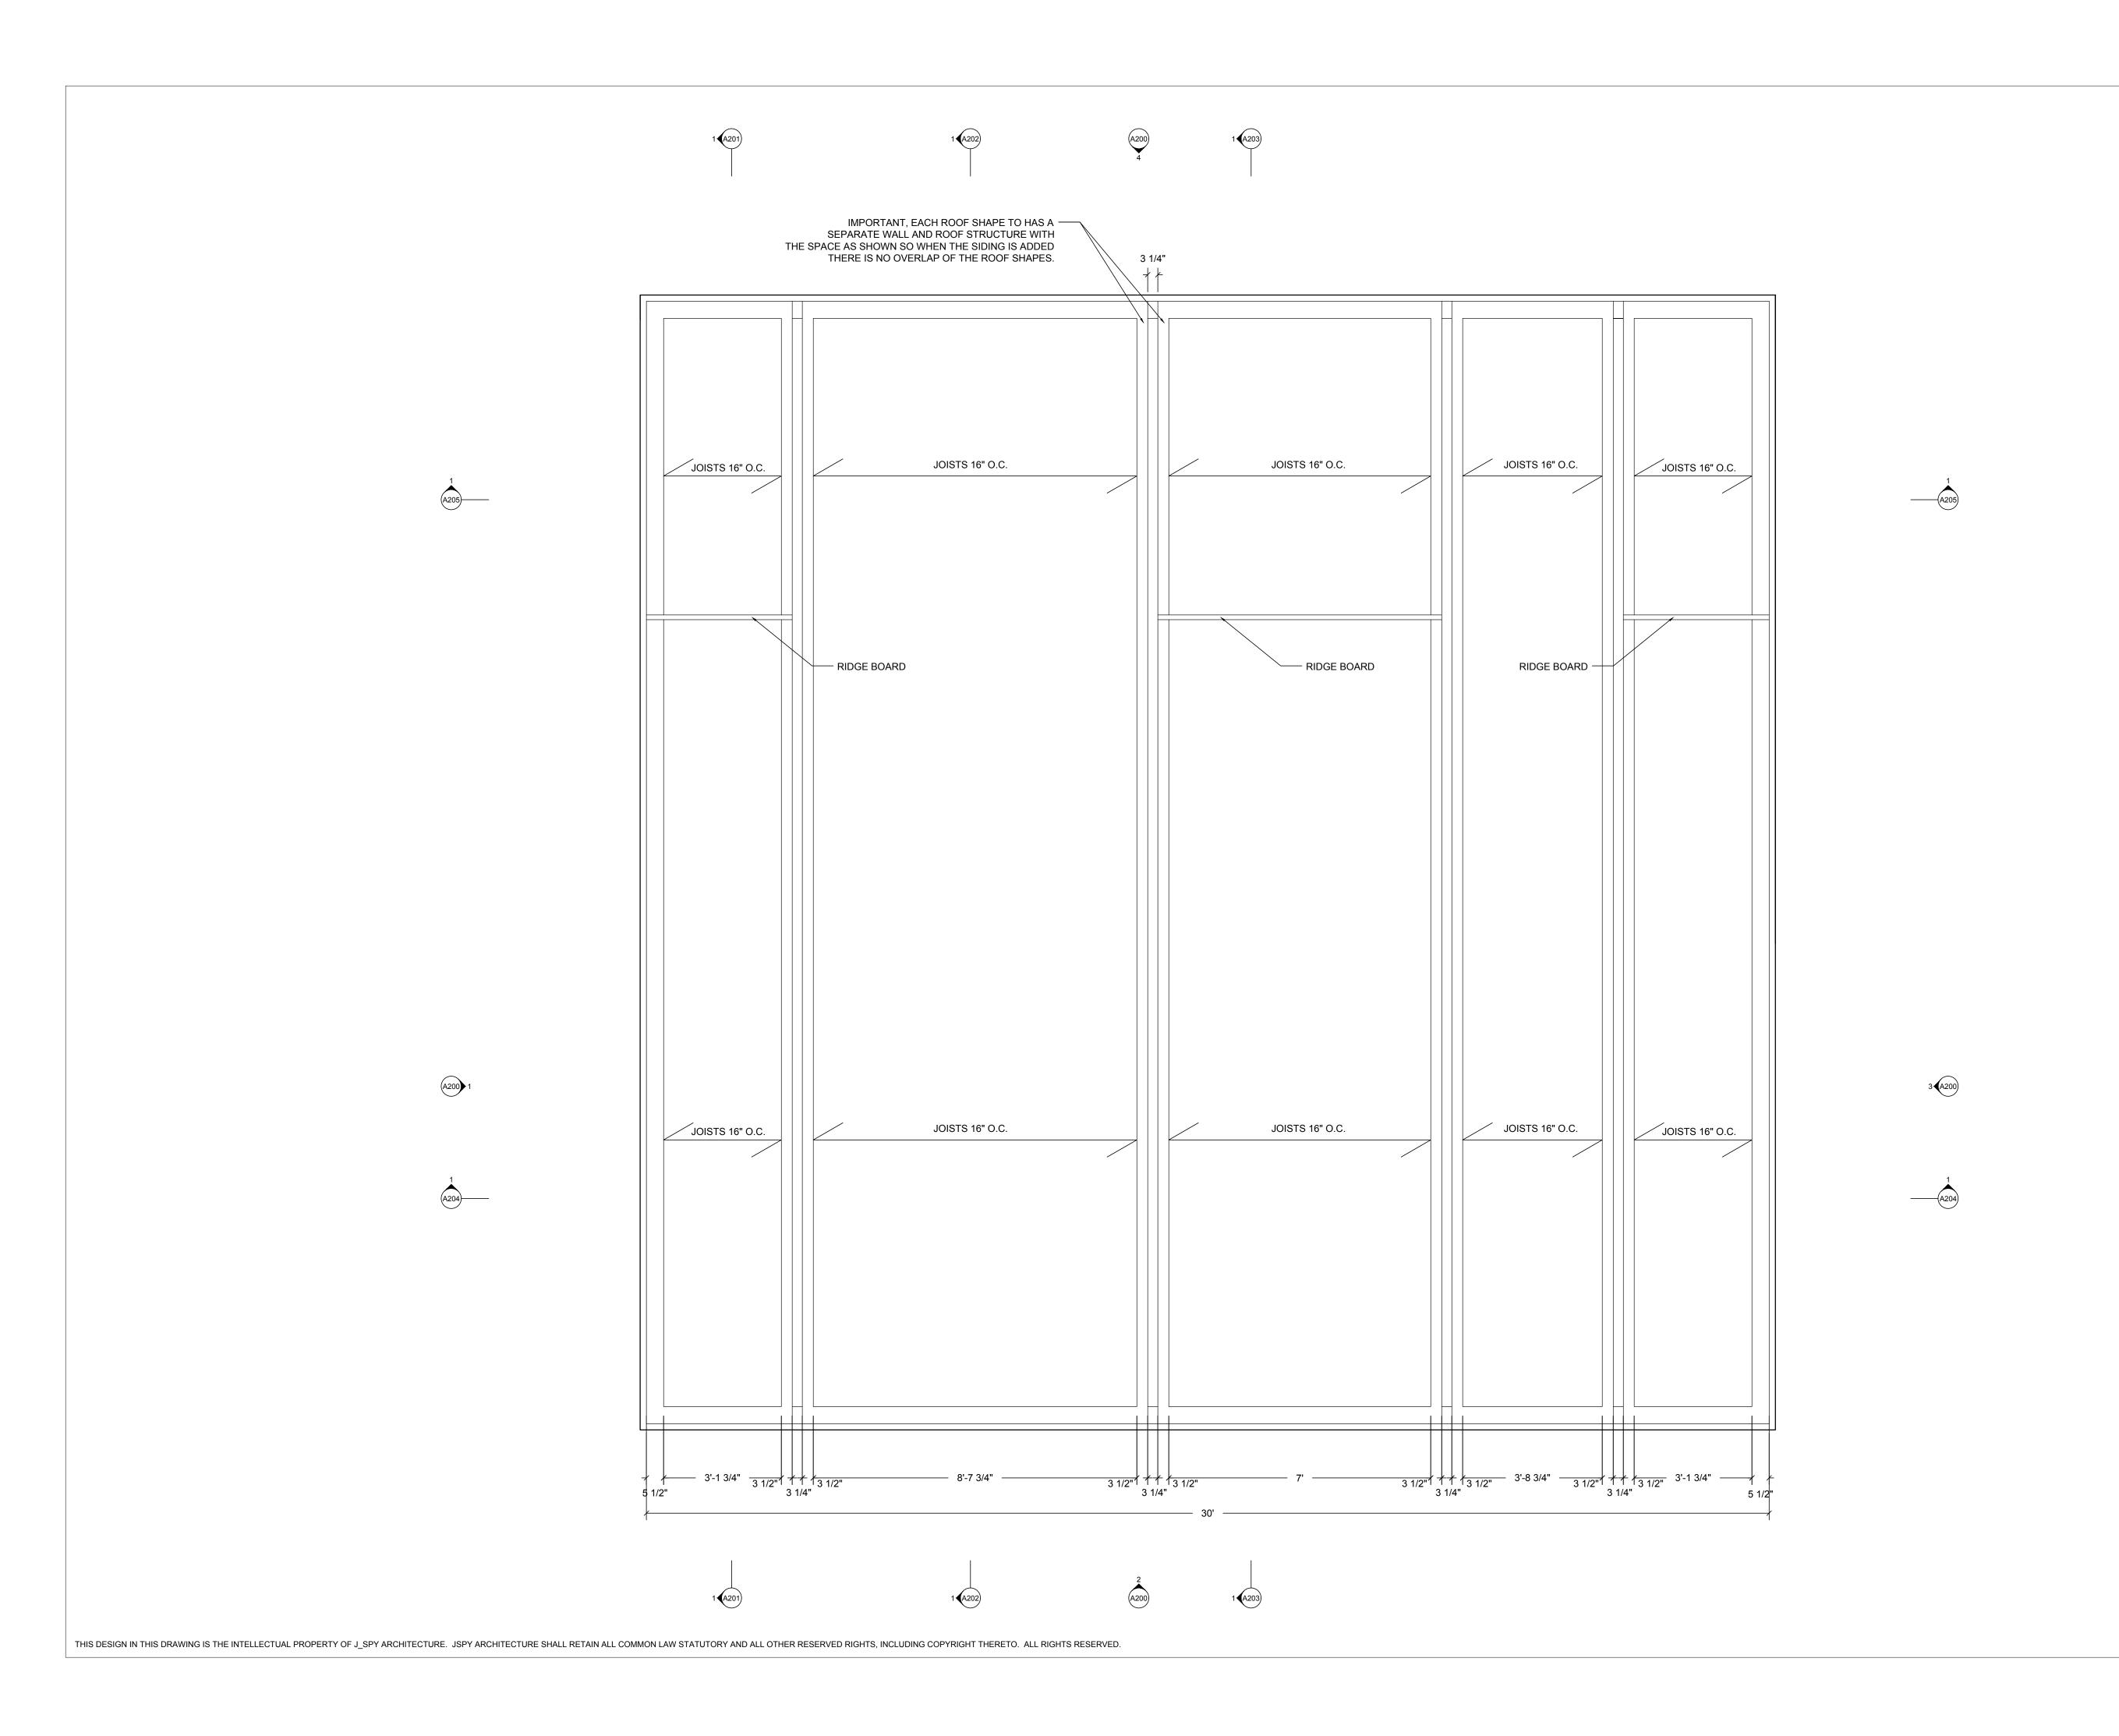

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DESIGN ARCHITECT


J_SPY ARCHITECTURE AND DESIGN


DATE: MARCH 7, 2024


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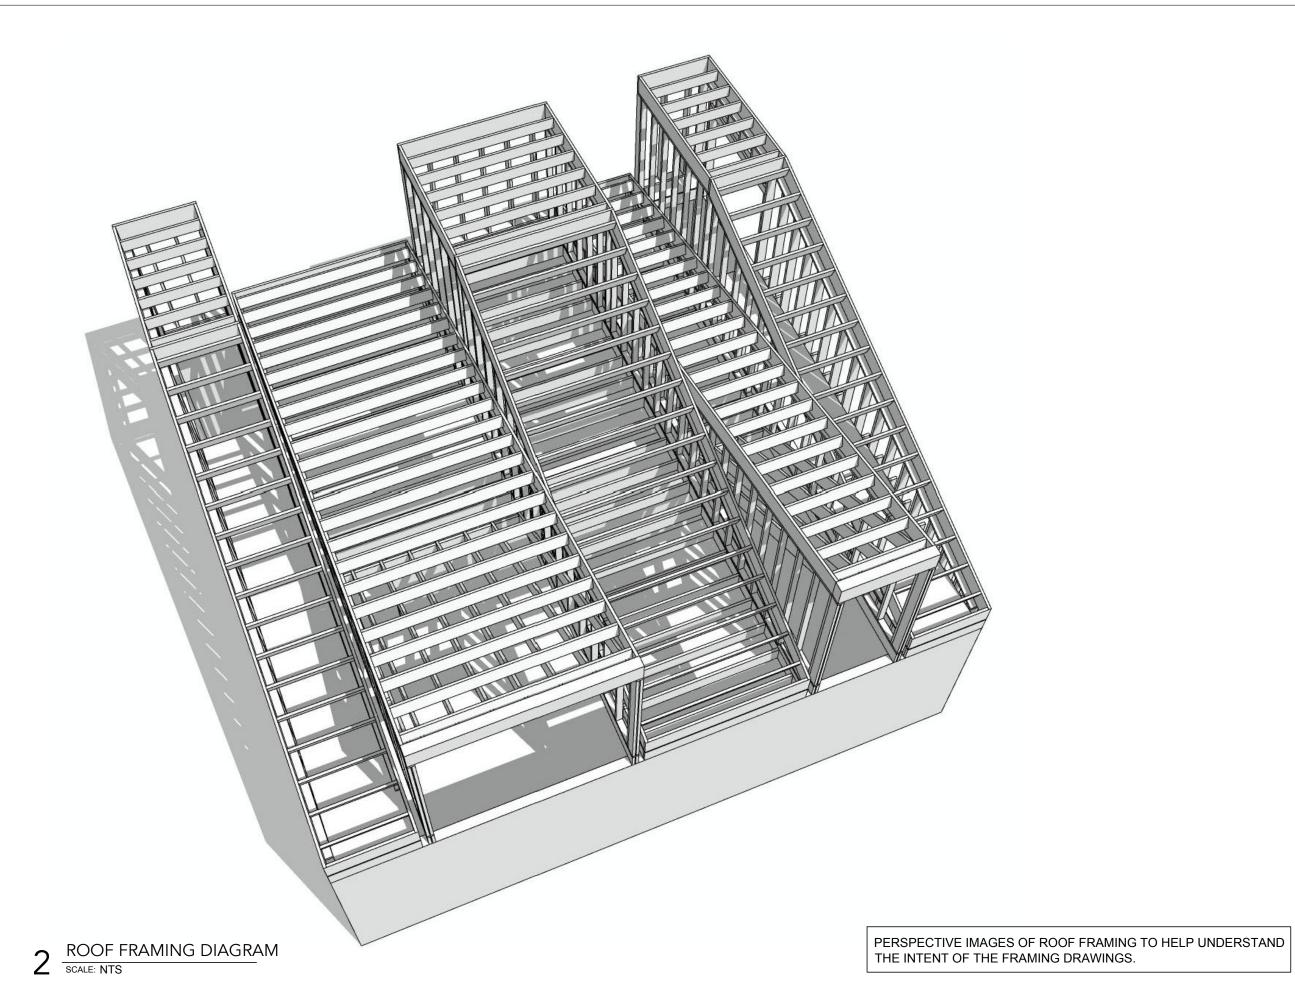
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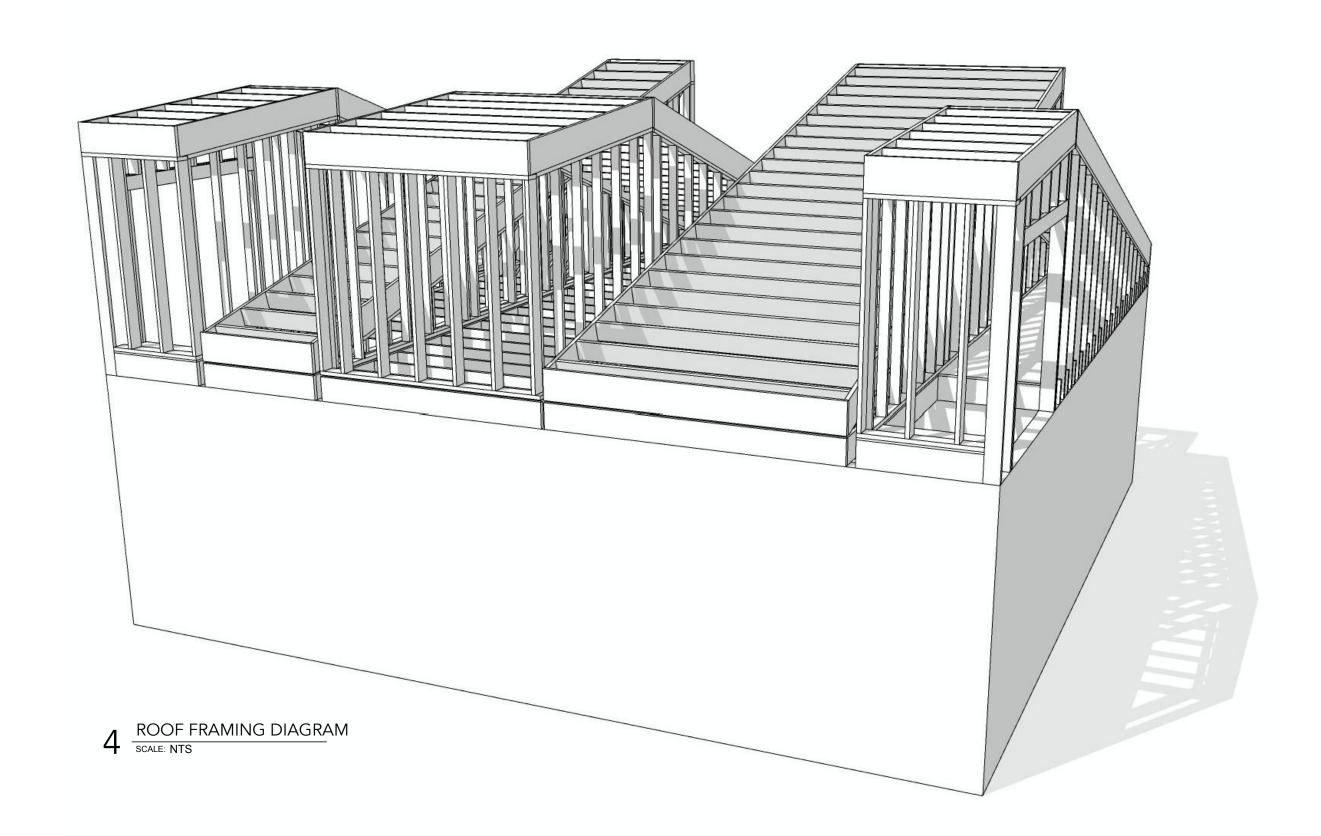
FRAMING PLAN UPPER ROOF





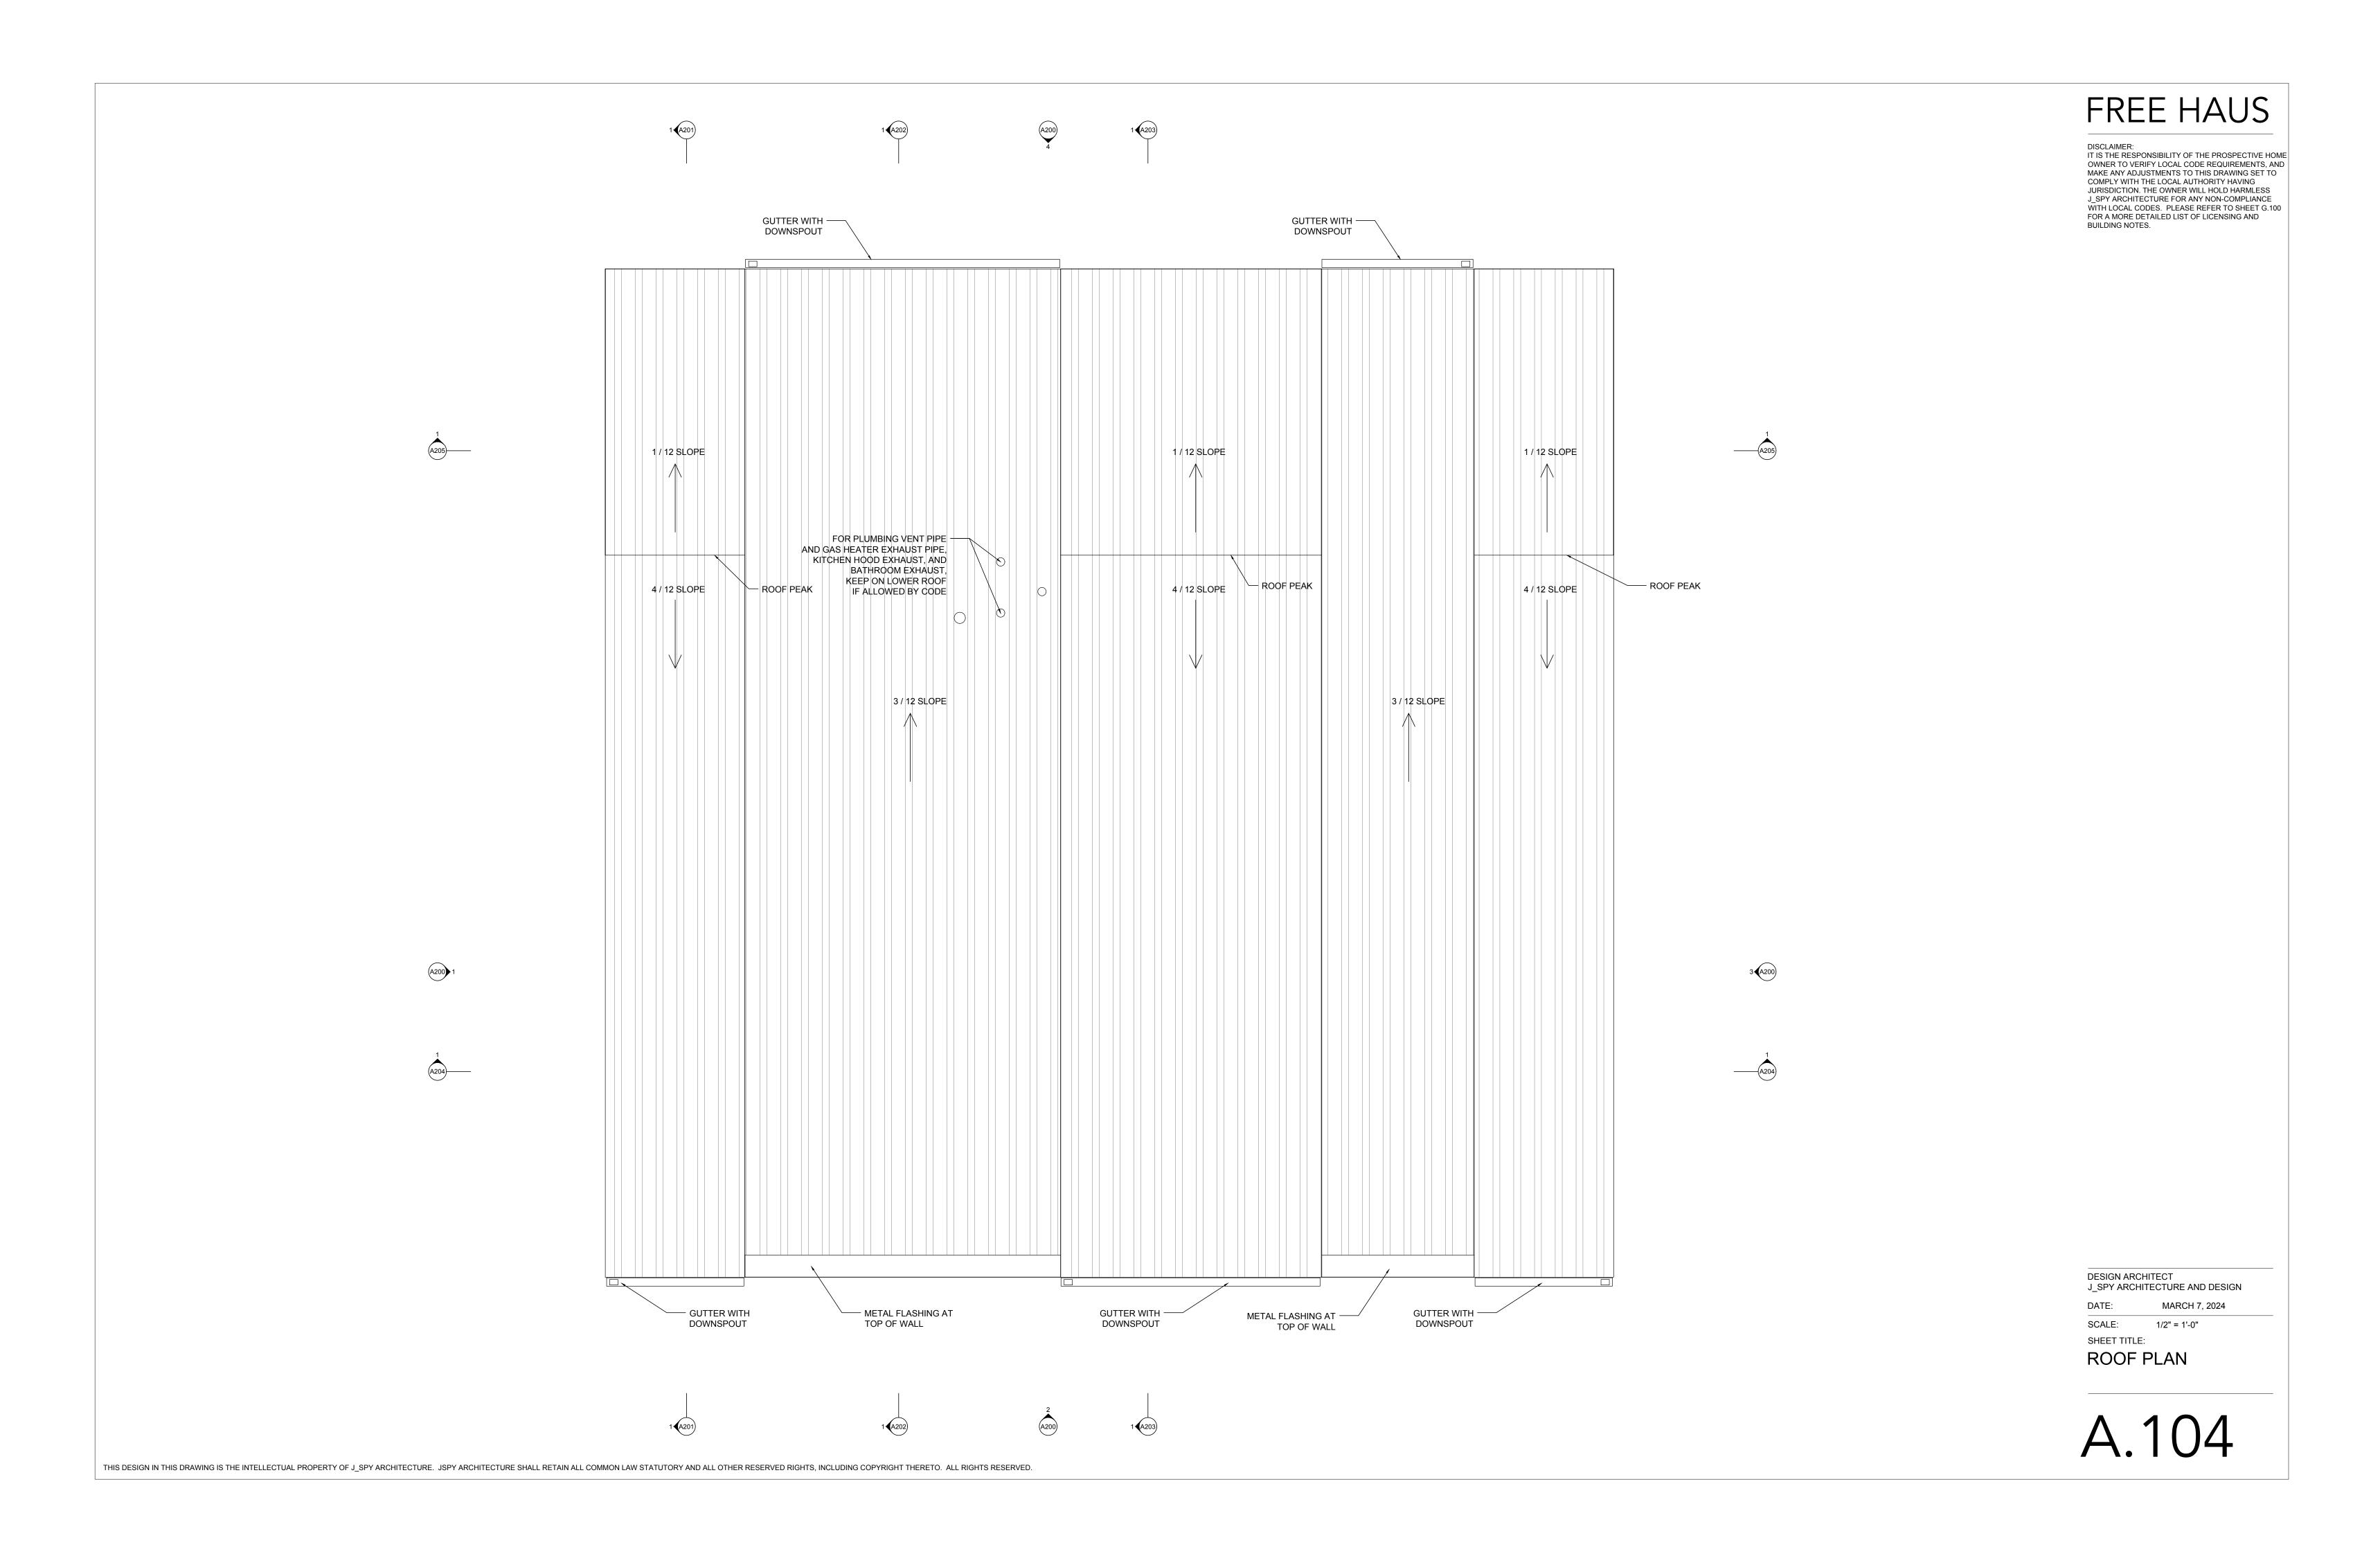

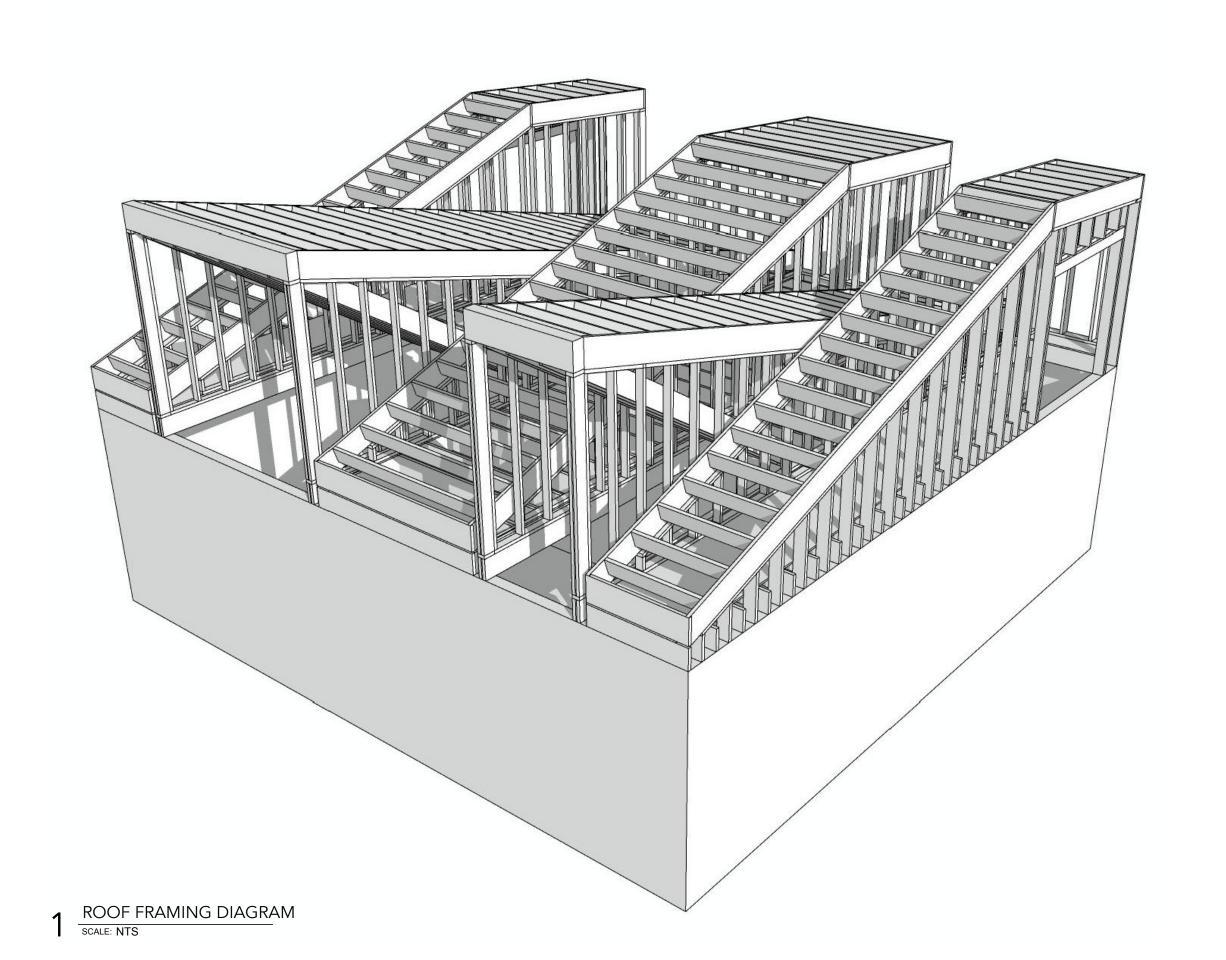

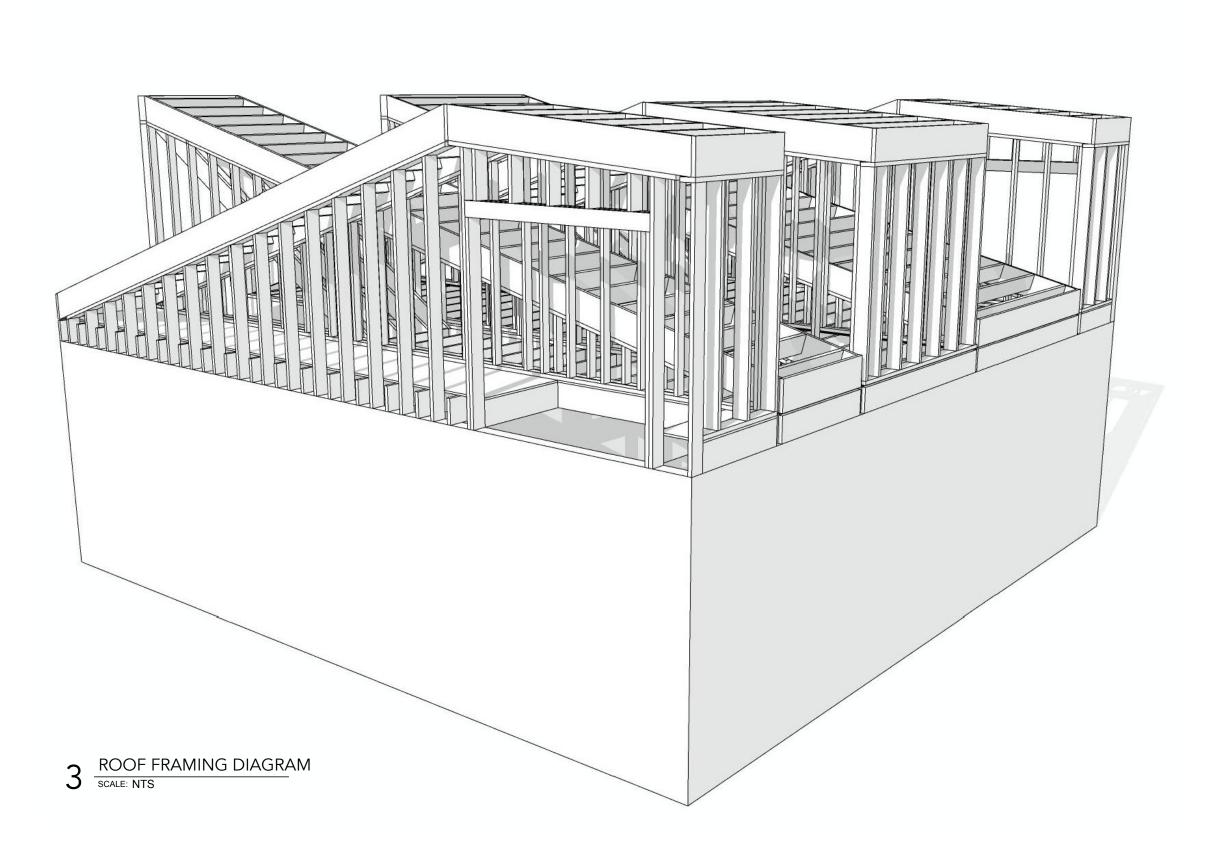


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DESIGN ARCHITECT
J_SPY ARCHITECTURE AND DESIGN
DATE: MARCH 7, 2024

SCALE: NTS
SHEET TITLE:

ROOF FRAMING DIAGRAMS

DISCLAIMER:
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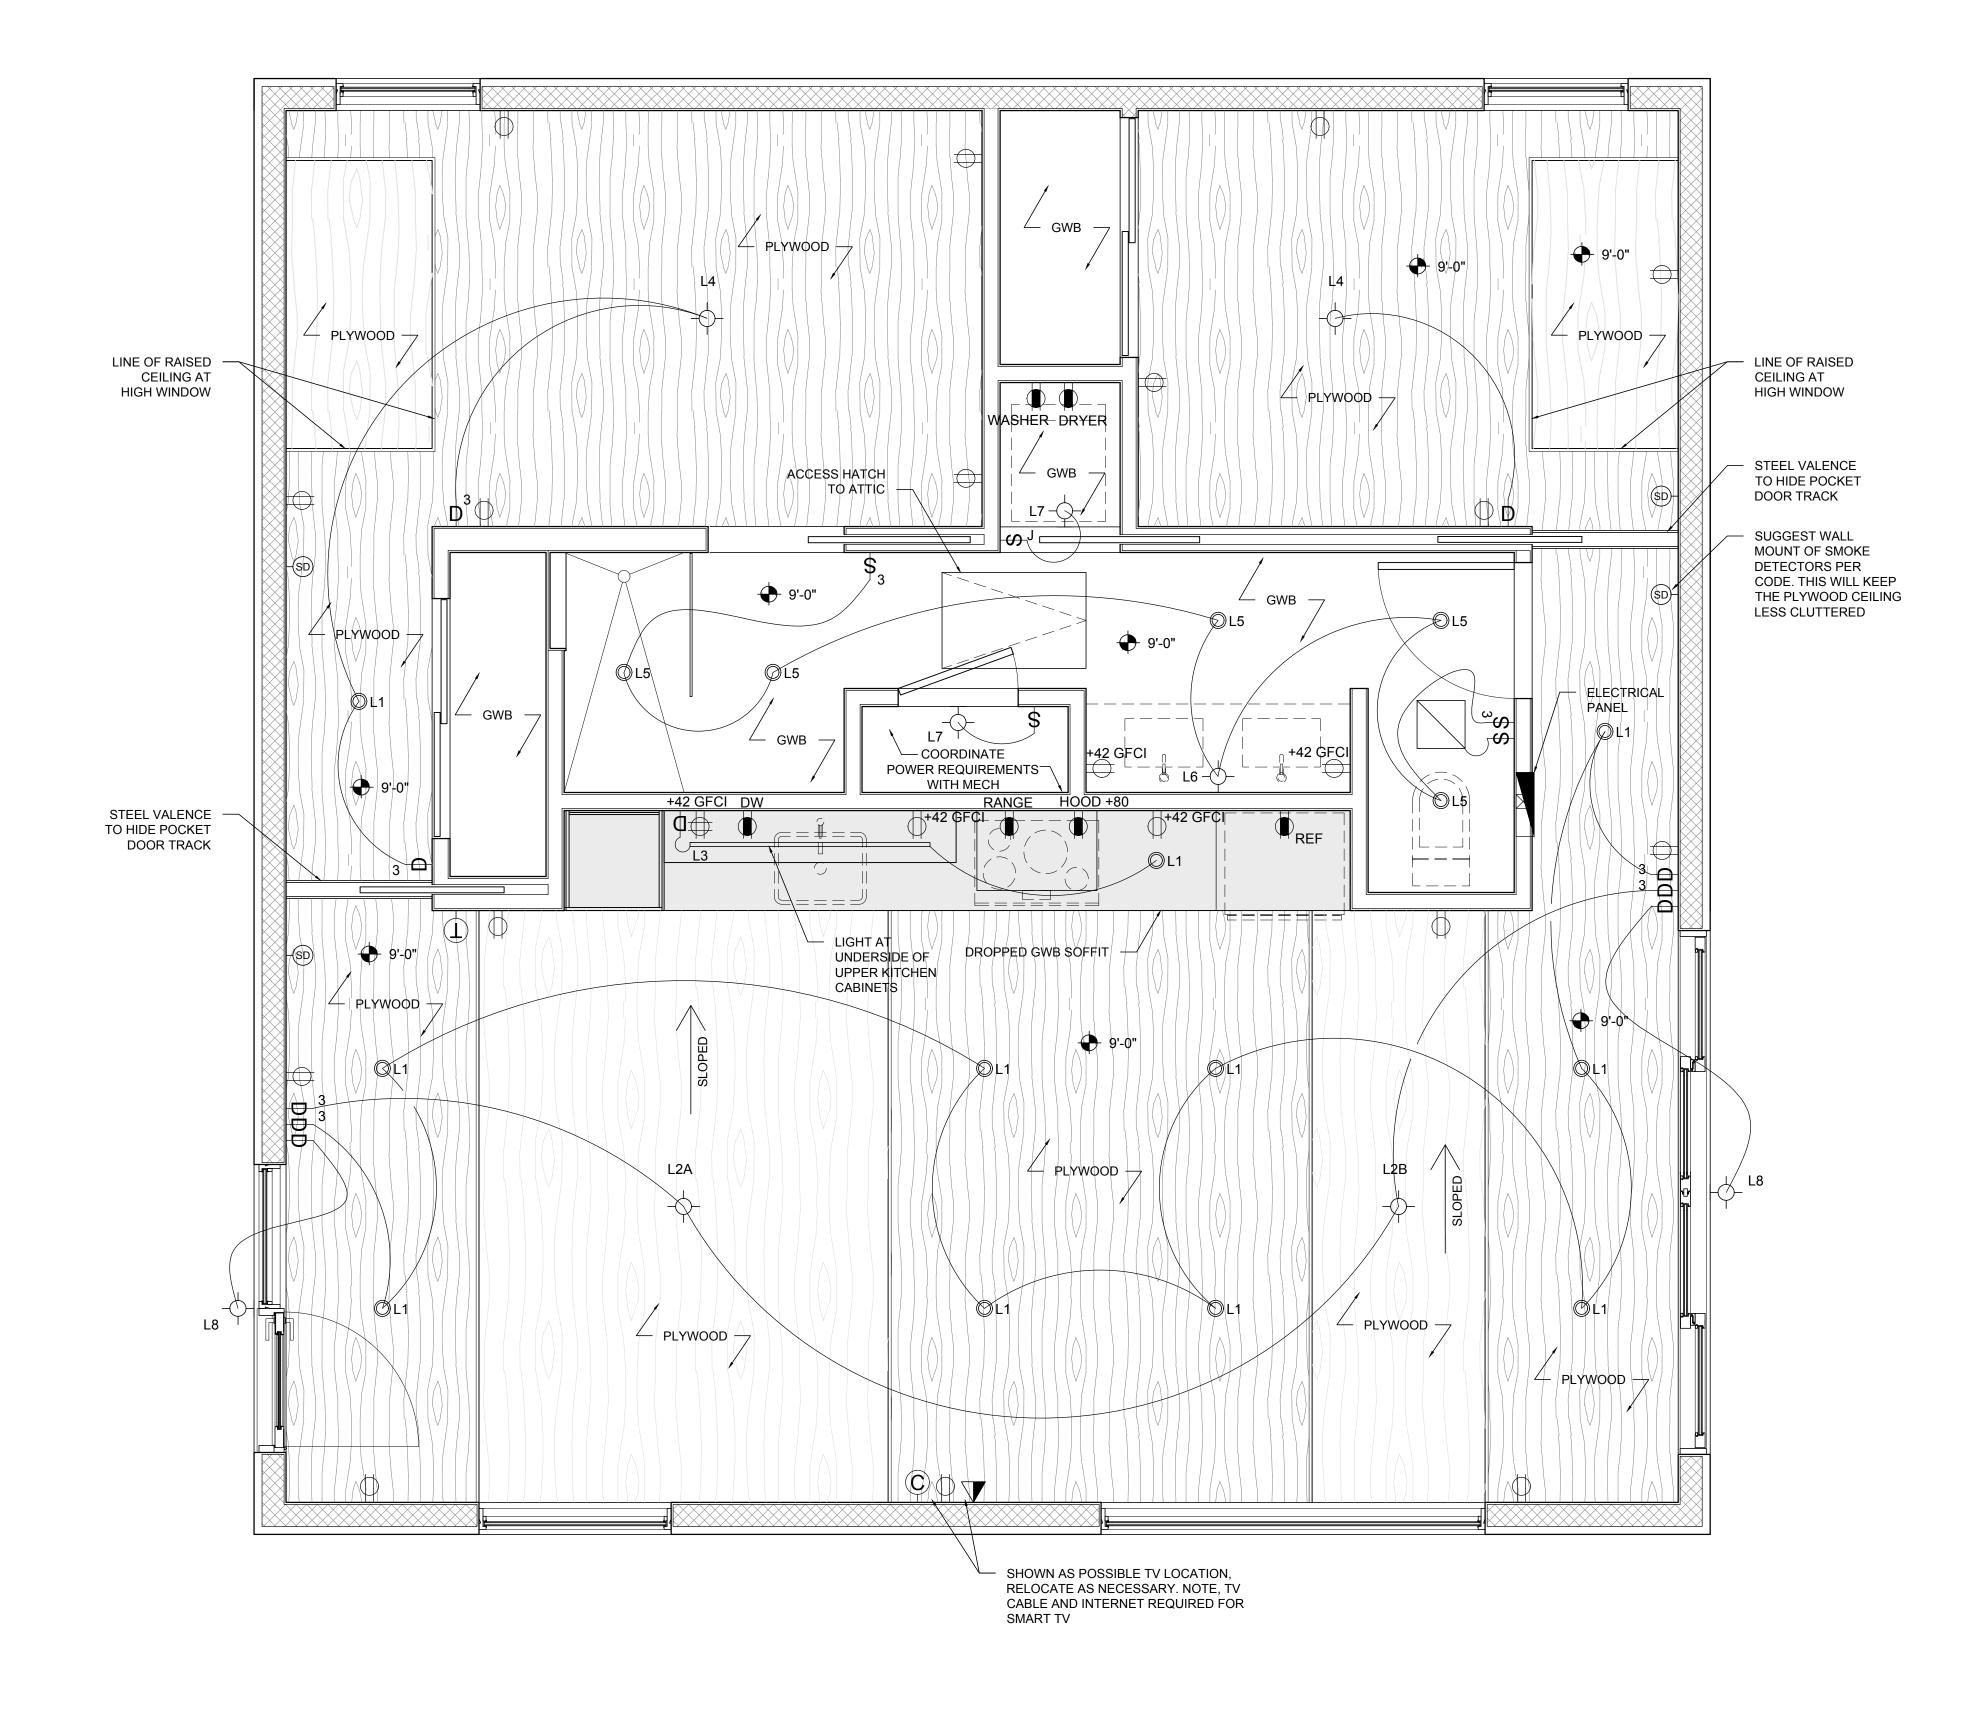
ELECTRICAL CONTRACTOR NOTES

1. ALL ELECTRICAL COVER PLATES TO BE SCREWLESS LEGRAND ADORNE IN A WHITE FINISH UNLESS OTHERWISE NOTED.

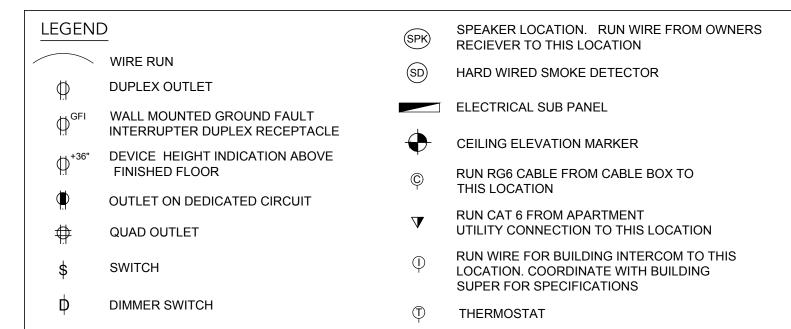2. ELECTRICAL CONTRACTOR IS RESPONSIBLE OR COORDINATING DIMMER SWITCHES WITH LIGHT FIXTURE TO INSURE PROPER FUNCTION

3. EACH NEW SMOKE DETECTOR SHALL BE INSTALLED IN ACCORDANCE WITH LOCAL CODES AND FIRE REGULATIONS.

FINISHED CEILING DOOR FRAME EDGE THERMOSTAT LIGHT SWITCH(S), DIMMER(S), ETC. GANG TOGETHER CLUSTERS AS SHOWIN IN ELECTRICAL PLAN DEFAULT HEIGHT FOR OUTLETS IS 12" AFF. FINISHED FLOOR



DESIGN ARCHITECT
J_SPY ARCHITECTURE AND DESIGN

DATE: MARCH 7, 2024

SCALE: 1/2" = 1'-0"

ELECTRICAL PLAN AND RCP

SHEET TITLE:

- SUGGESTED ROOF MATERIAL METAL PANEL FROM PAC-CLAD SNAP CLAD IN SMOOTH PANEL: 10", 12", OR 16" ELEV: 18' - 5 1/2" T.O. PEAK ELEV: 18' - 5 1/2" T.O. PEAK GUTTER — MATCH SIDING WITH MAIN FACADE DOWNSPOUT — ELEV: 0'-0" FLOOR LEVEL ELEV: 0'-0" FLOOR LEVEL 1 ELEVATION 1 SCALE: 1/4" = 1'-0" 2 ELEVATION 2 | SCALE: 1/4" = 1'-0" SUGGESTED ROOF MATERIAL METAL — PANEL FROM PAC-CLAD SNAP CLAD IN SMOOTH PANEL: 10", 12", OR 16" ELEV: 18' - 5 1/2" T.O. PEAK DOWNSPOUT ELEV: 0'-0" FLOOR LEVEL ELEV: 0'-0" FLOOR LEVEL 4 ELEVATION 4 | SCALE: 1/4" = 1'-0" 3 ELEVATION 3 | SCALE: 1/4" = 1'-0"

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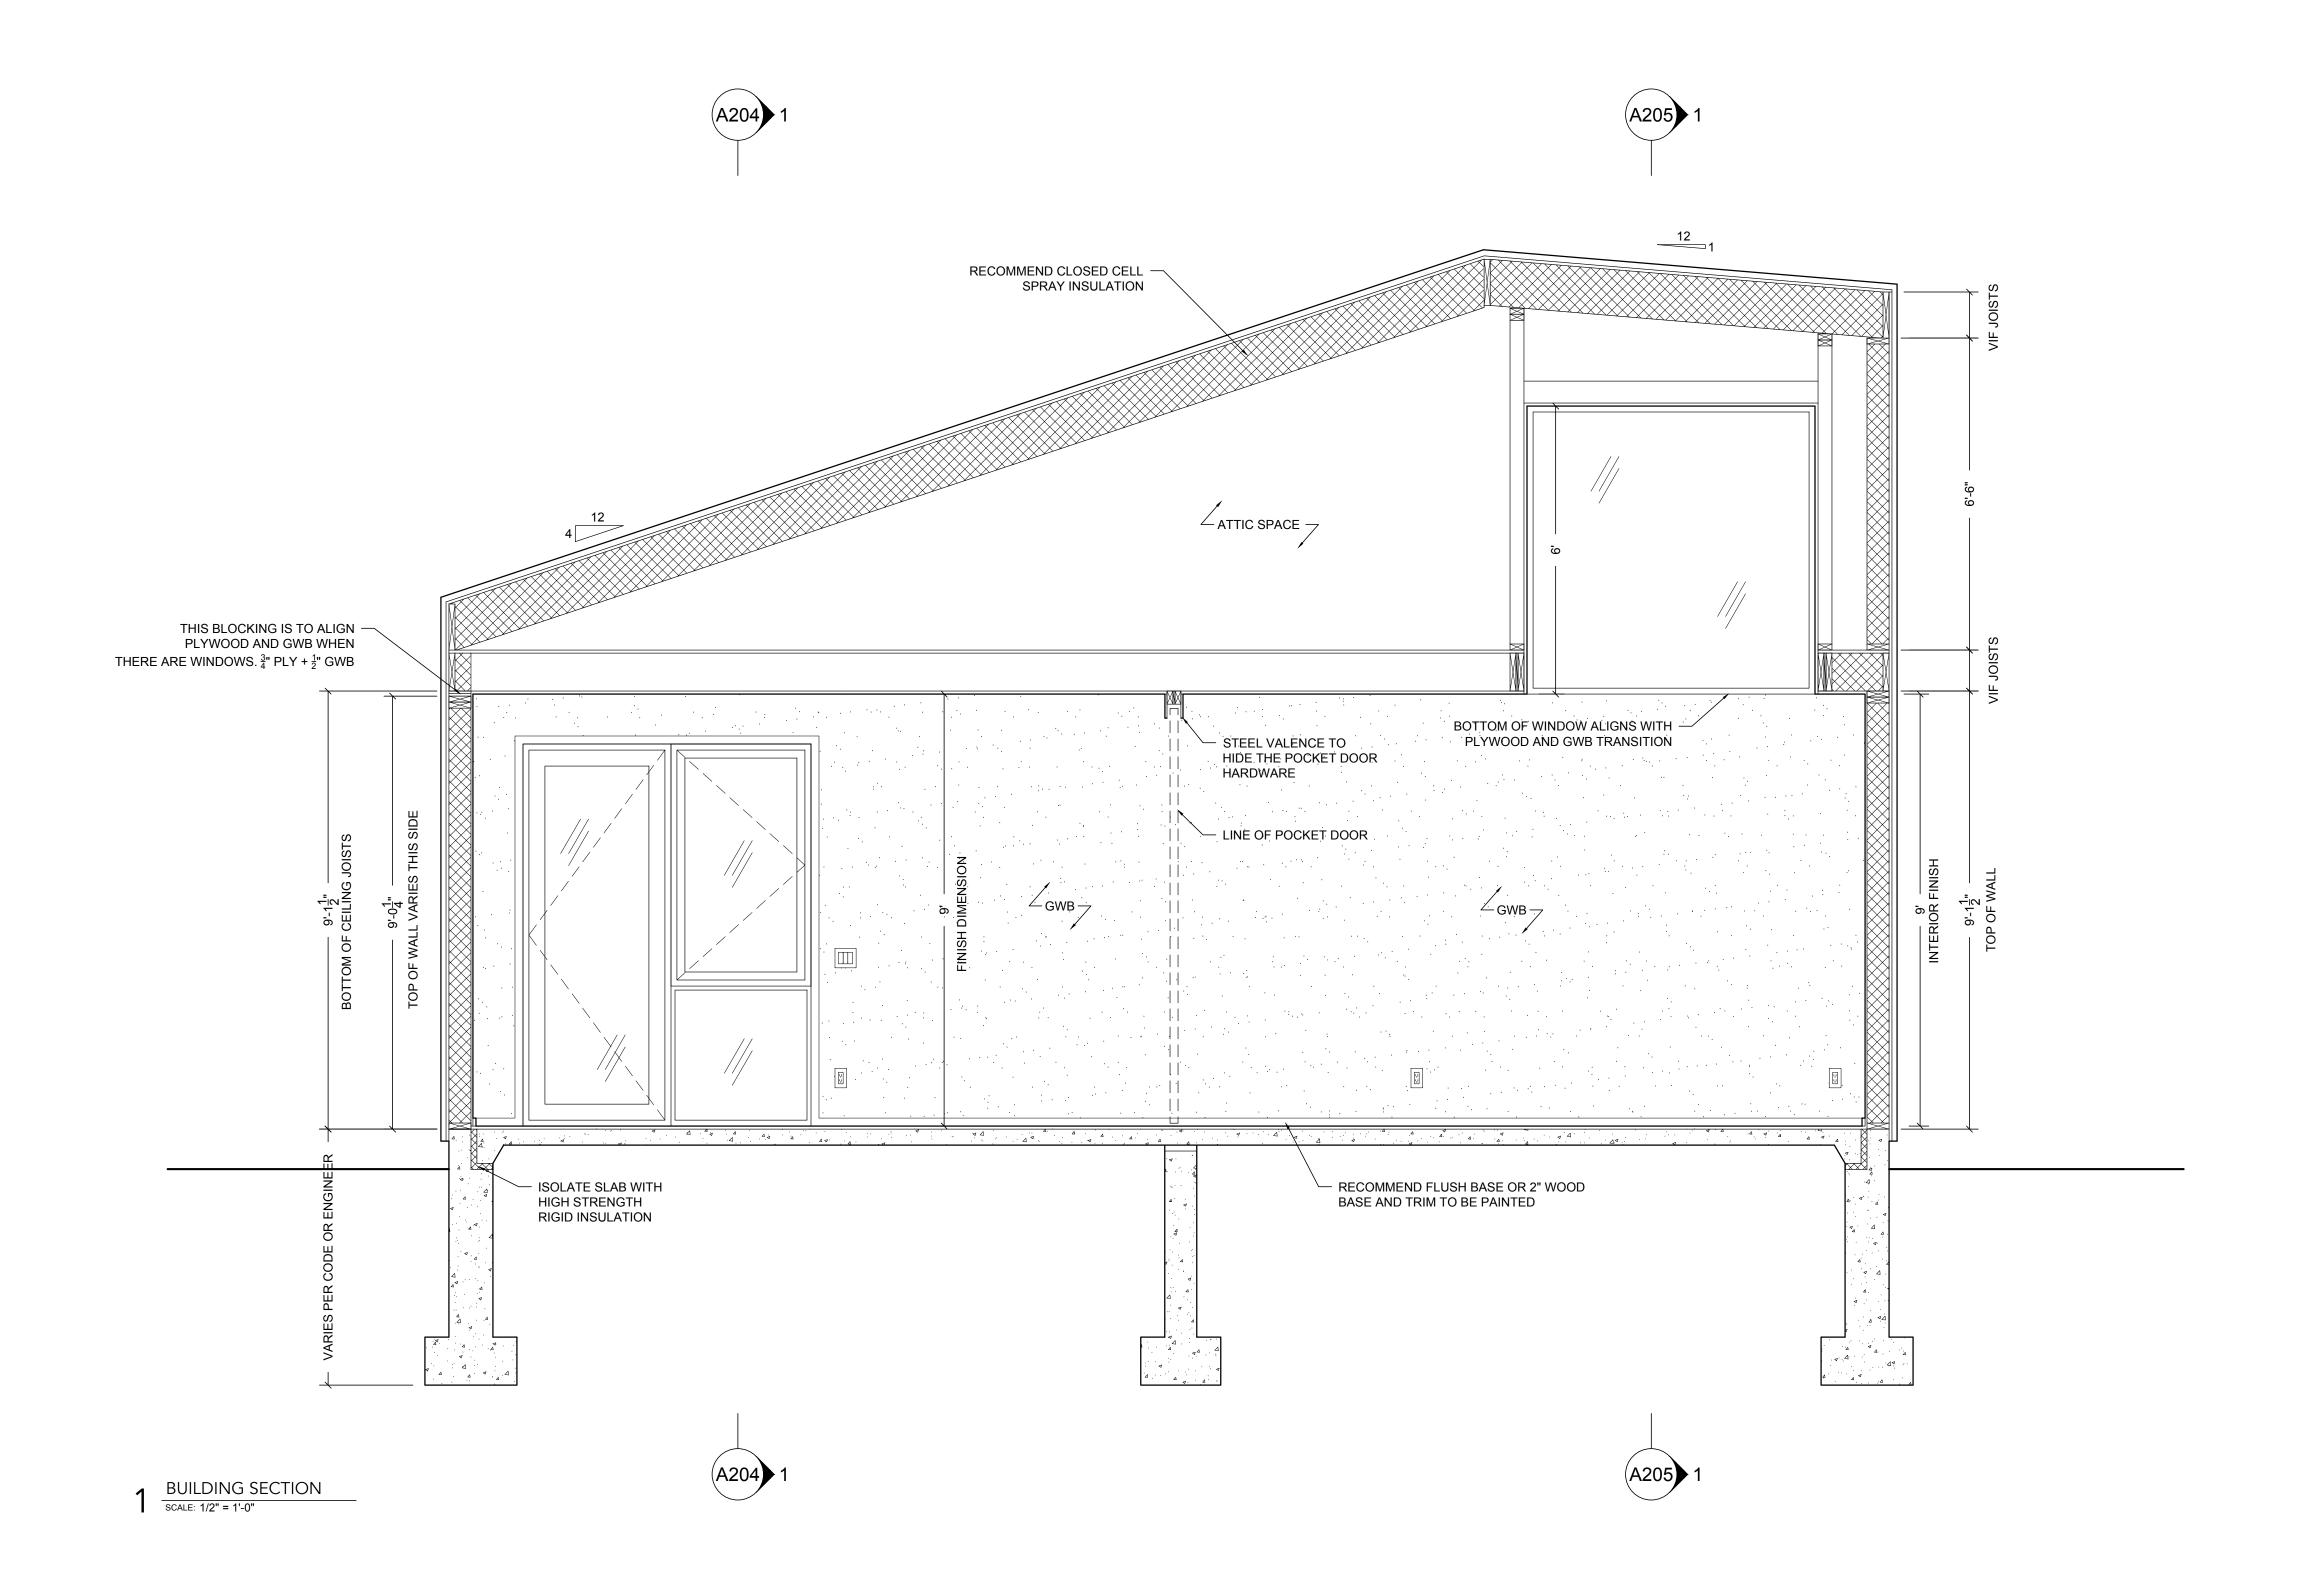
FREE HAUS

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DESIGN ARCHITECT
J_SPY ARCHITECTURE AND DESIGN
DATE: MARCH 7, 2024
SCALE: 1/4" = 1'-0"

SHEET TITLE:
BUILDING ELEVATIONS

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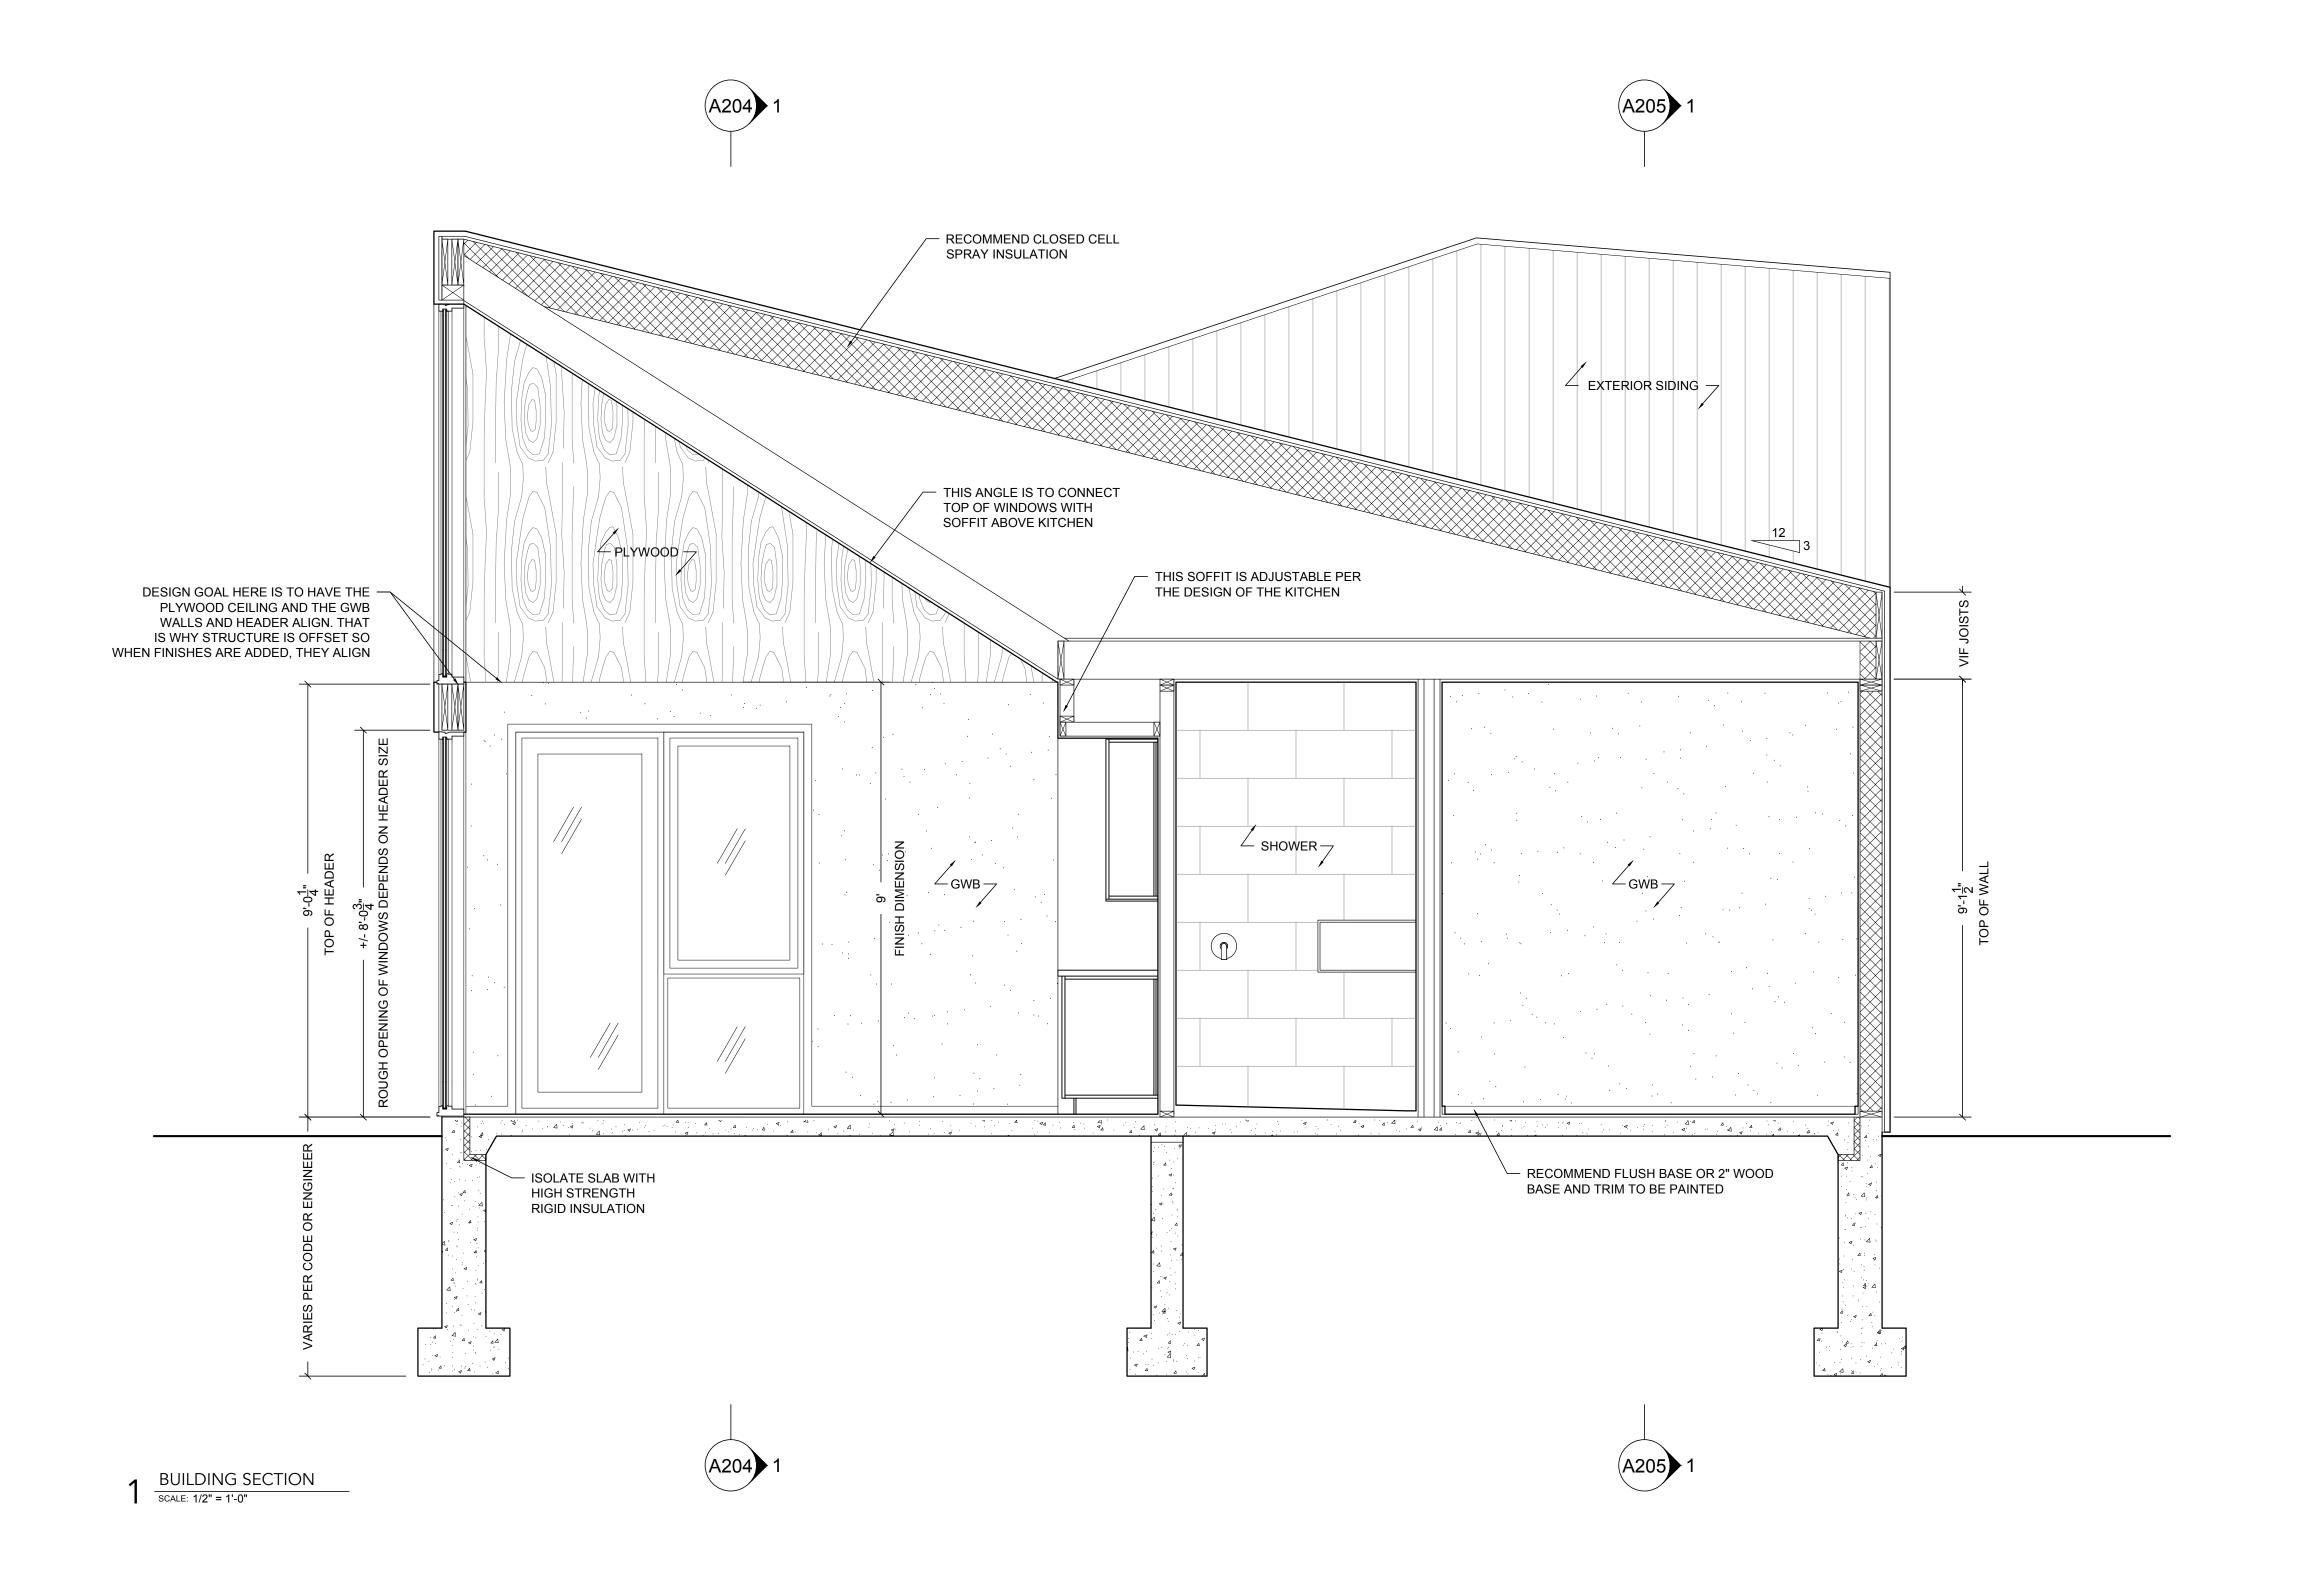


DESIGN ARCHITECT J_SPY ARCHITECTURE AND DESIGN MARCH 7, 2024

SCALE: 1/2" = 1'-0" SHEET TITLE:

BUILDING SECTION

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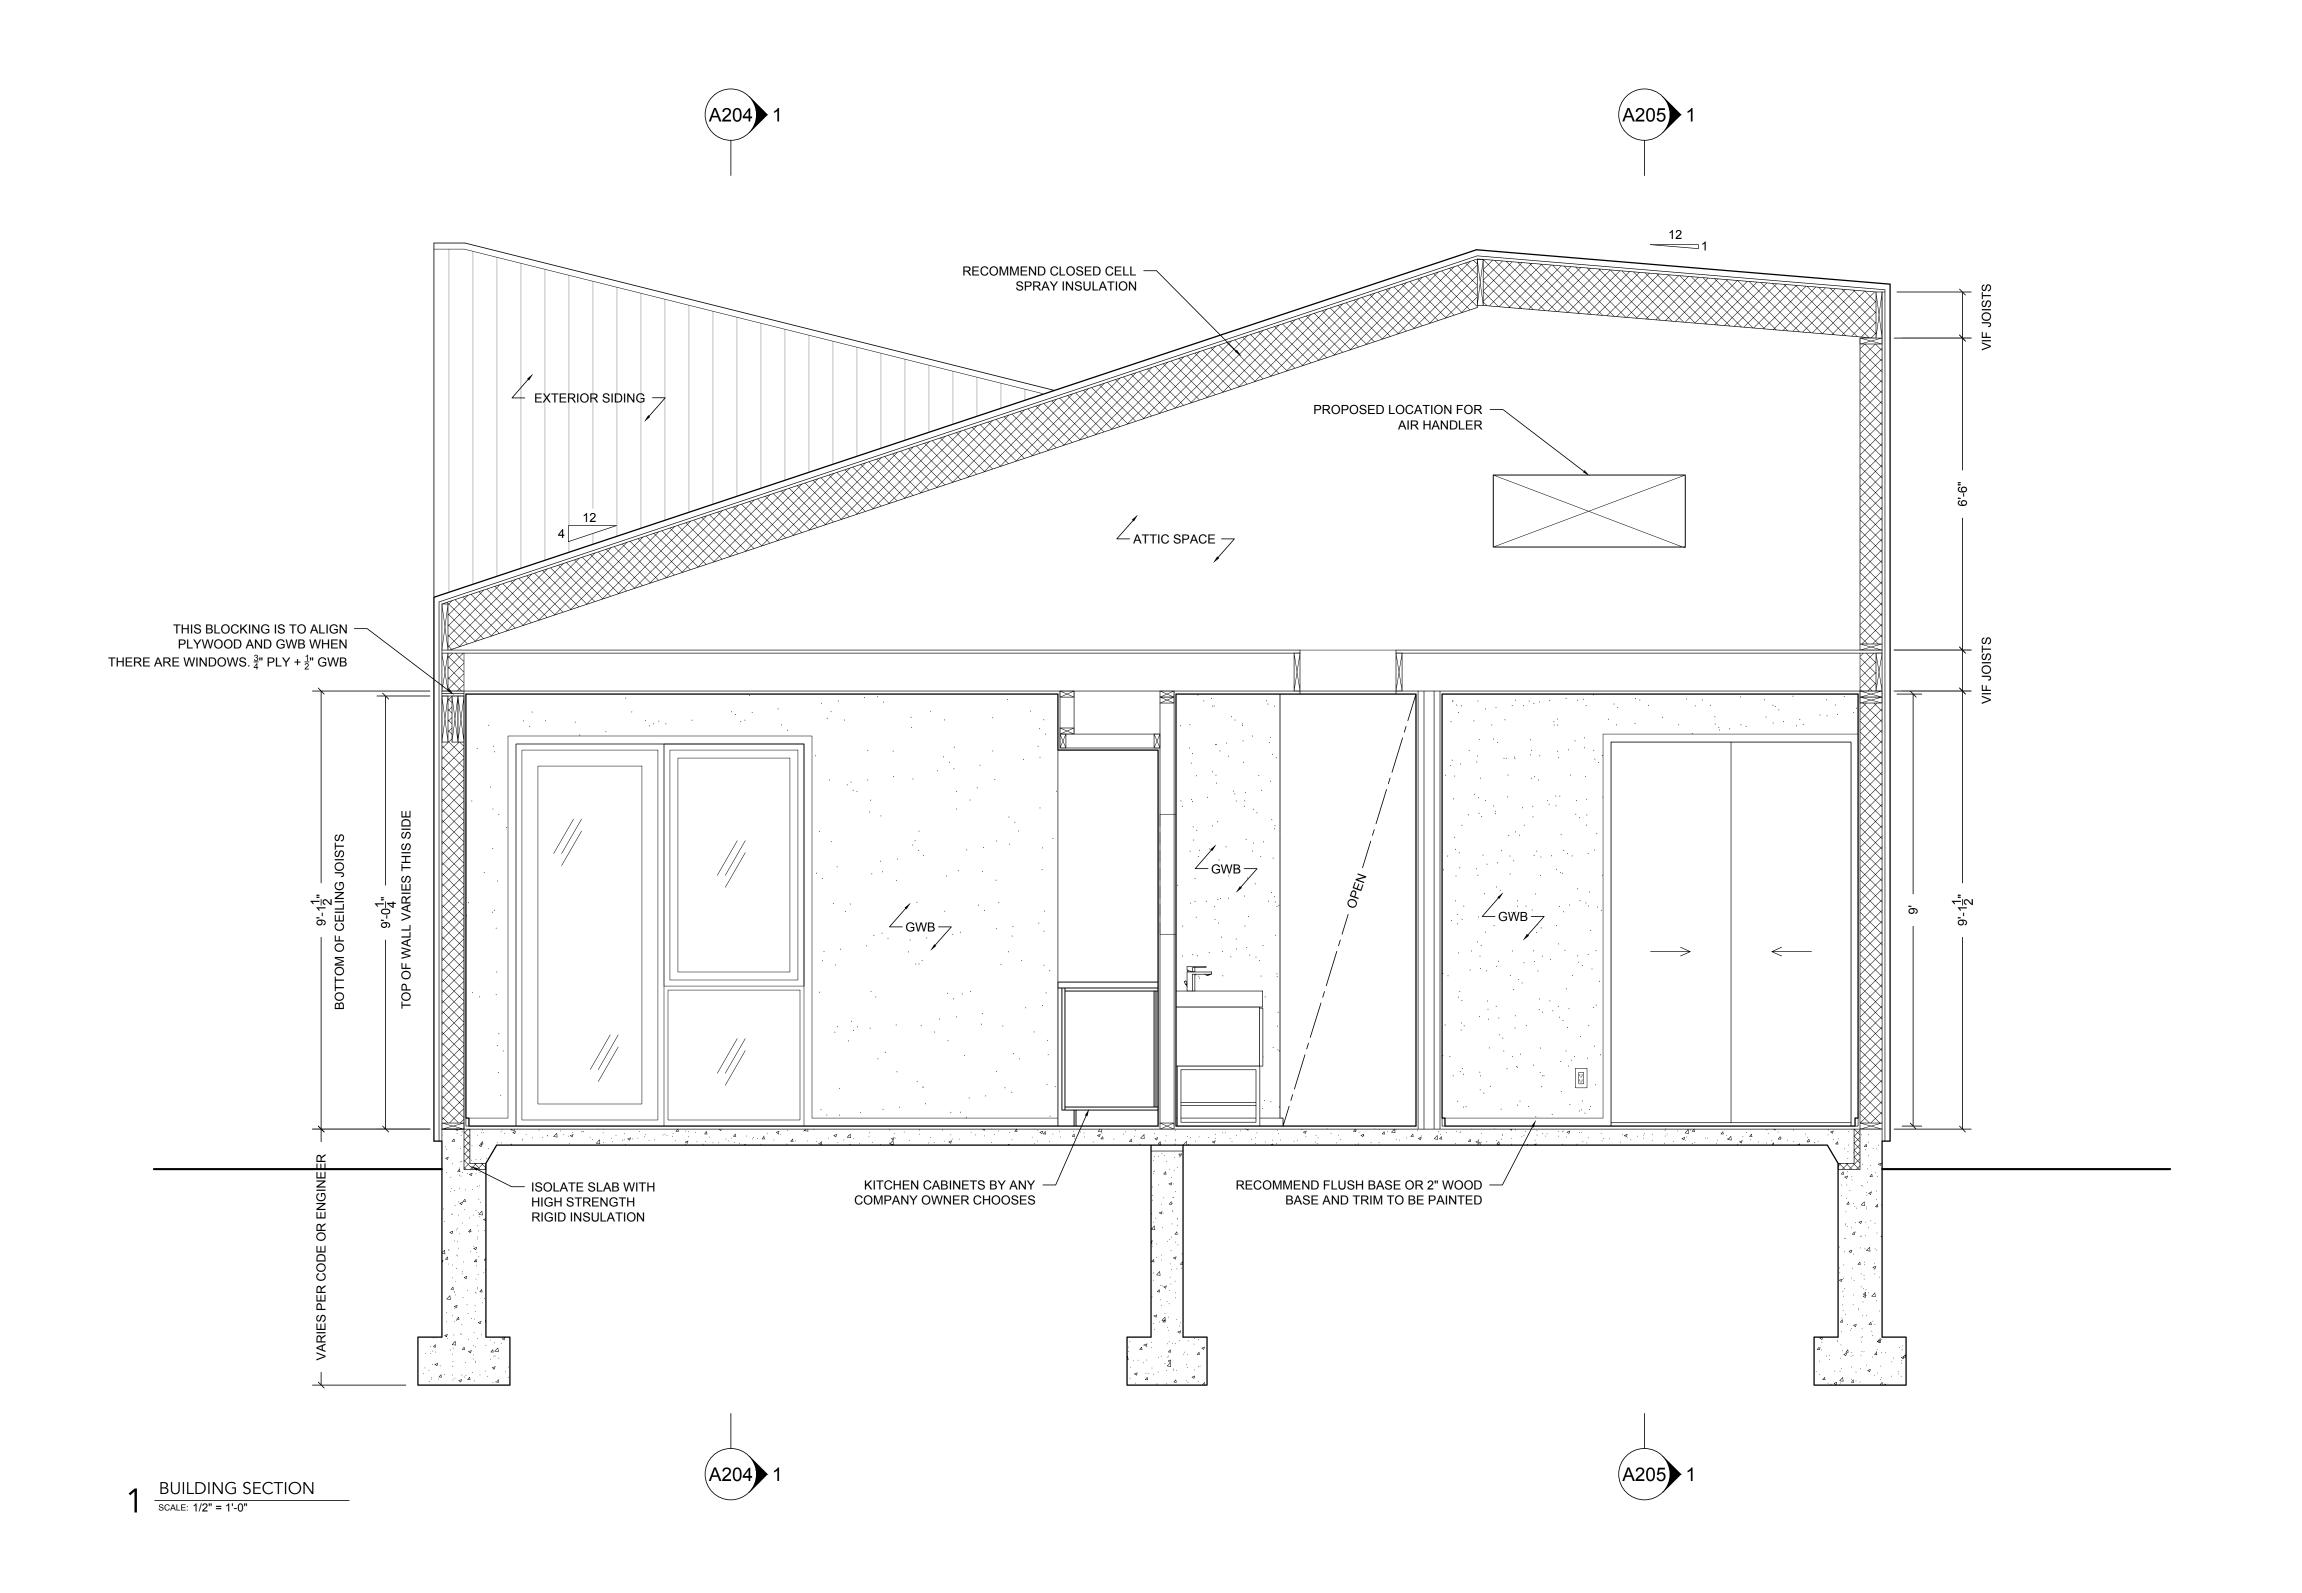


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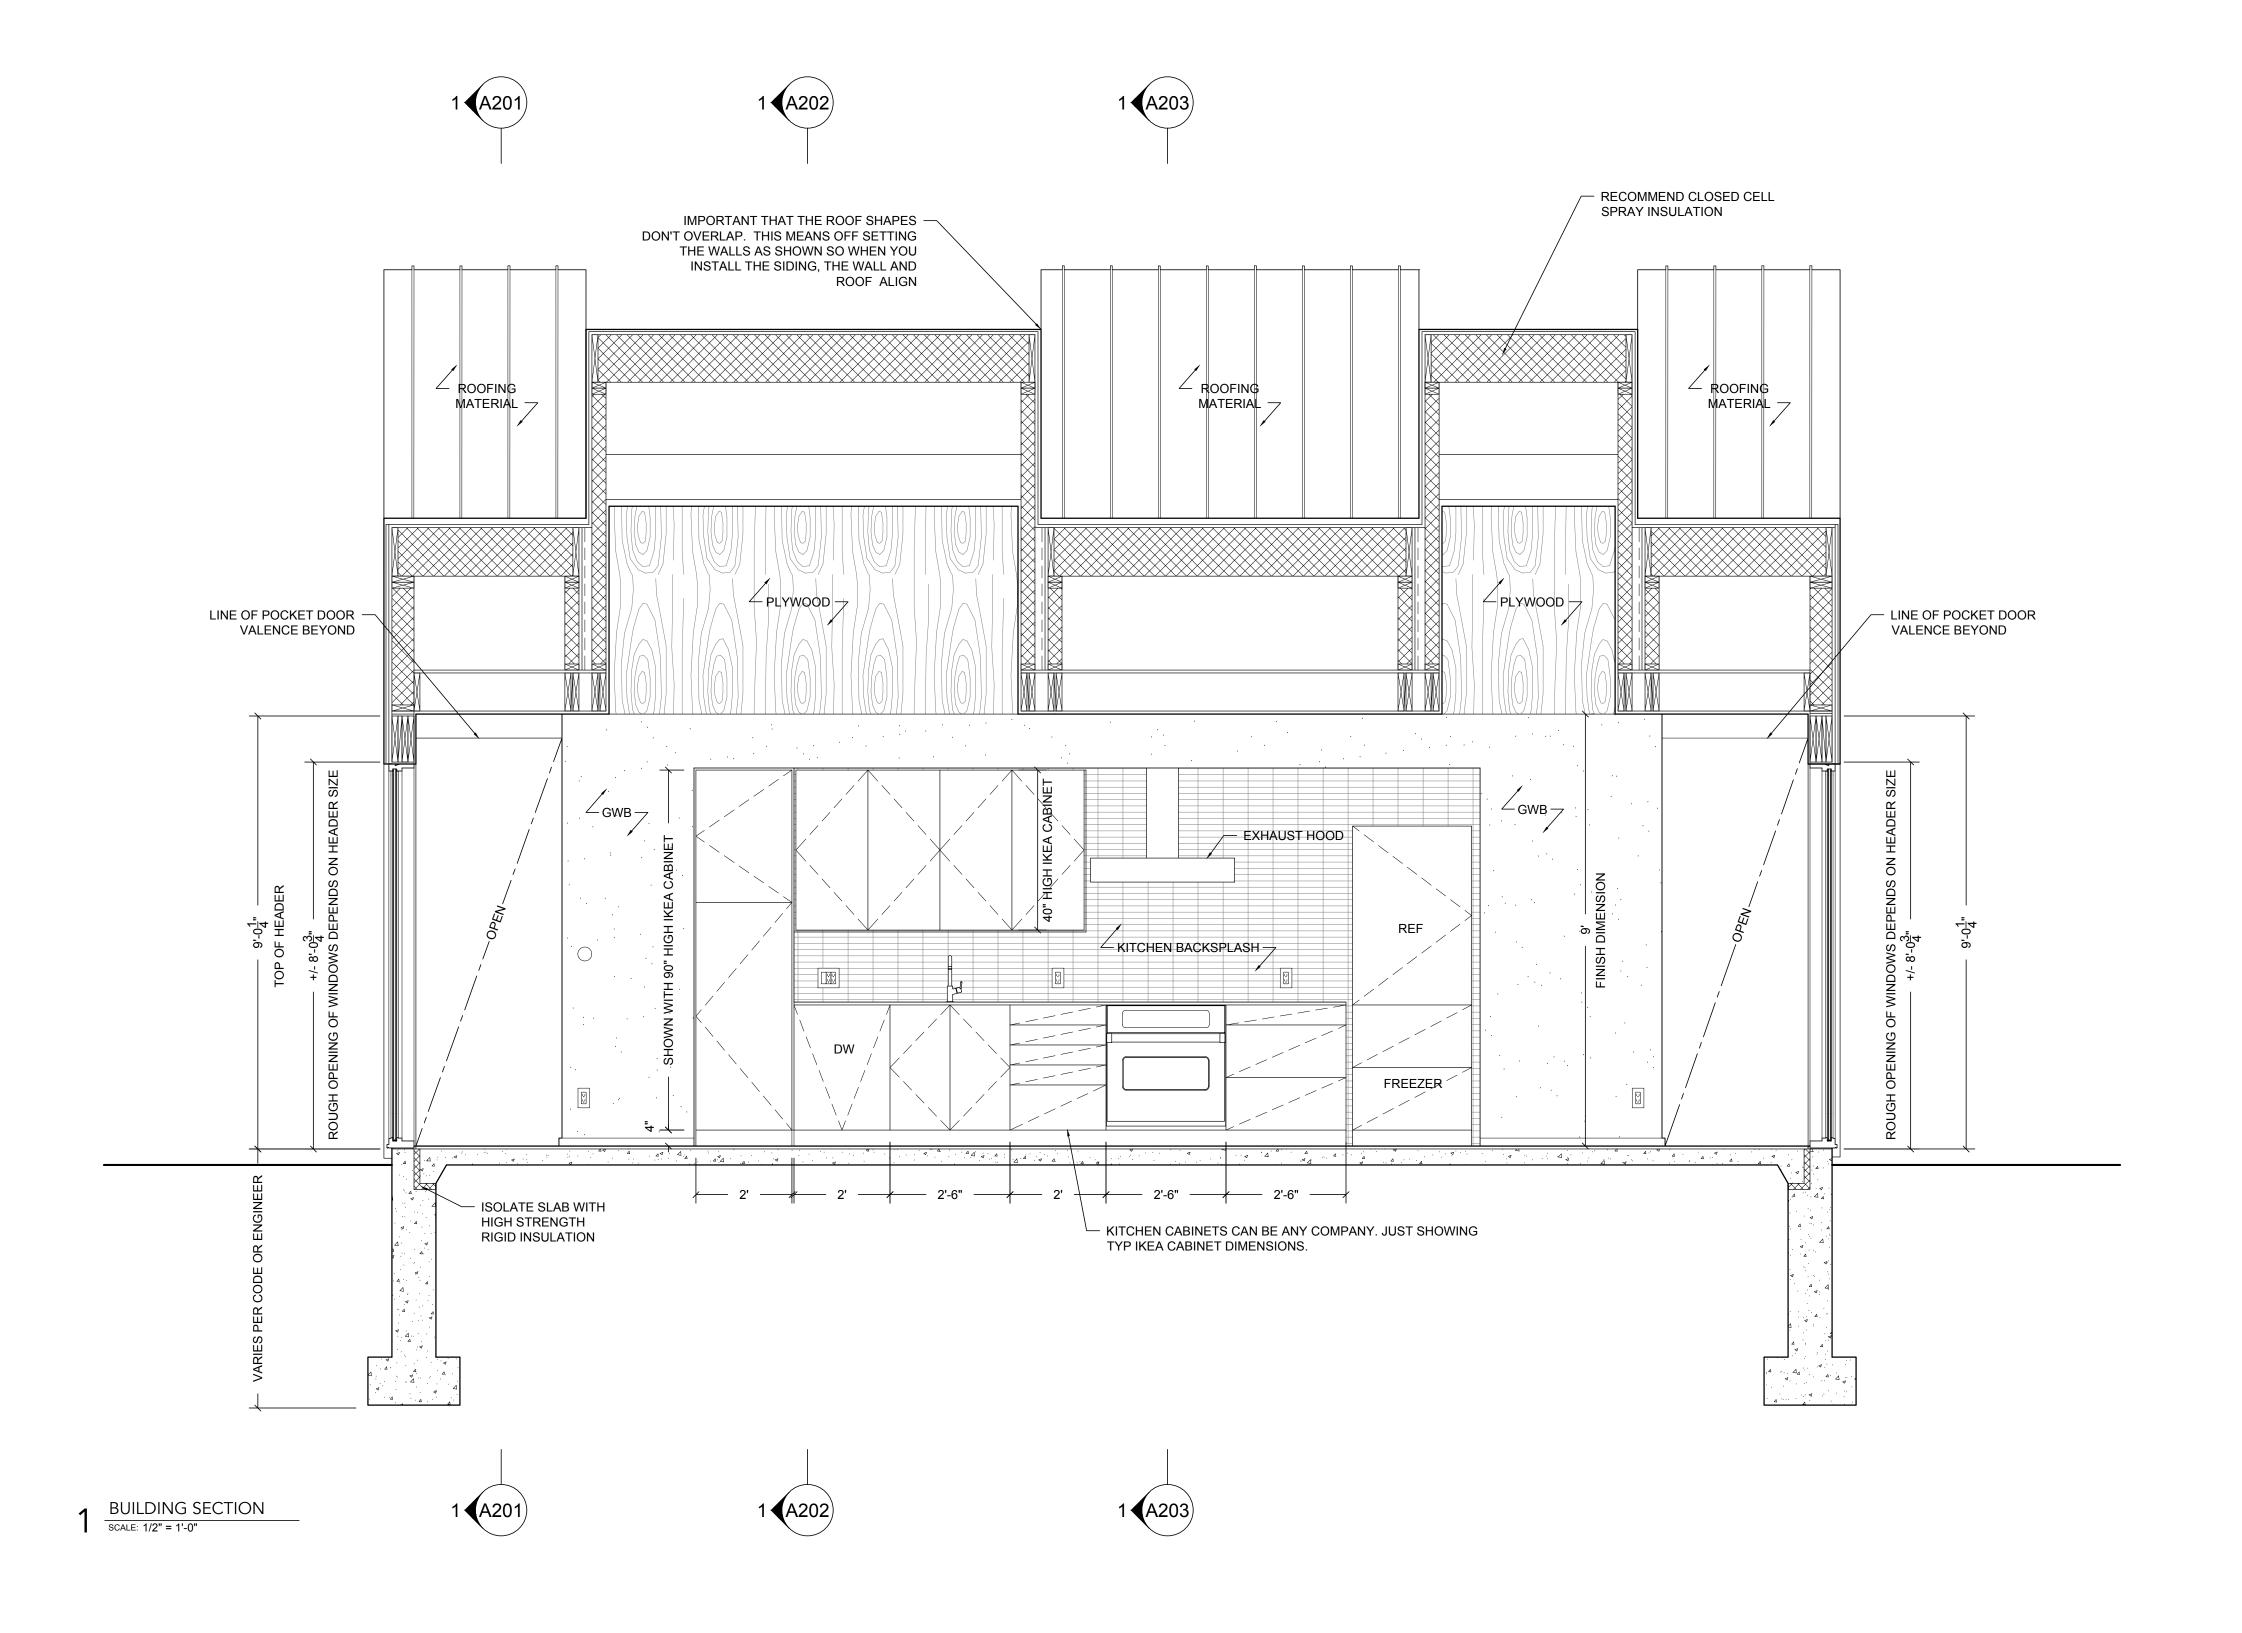
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BUILDING NOTES.

FOR A MORE DETAILED LIST OF LICENSING AND



DESIGN ARCHITECT
J_SPY ARCHITECTURE AND DESIGN


DATE: MARCH 7, 2024

SCALE: 1/2" = 1'-0"

SHEET TITLE:
BUILDING SECTION

A O O A

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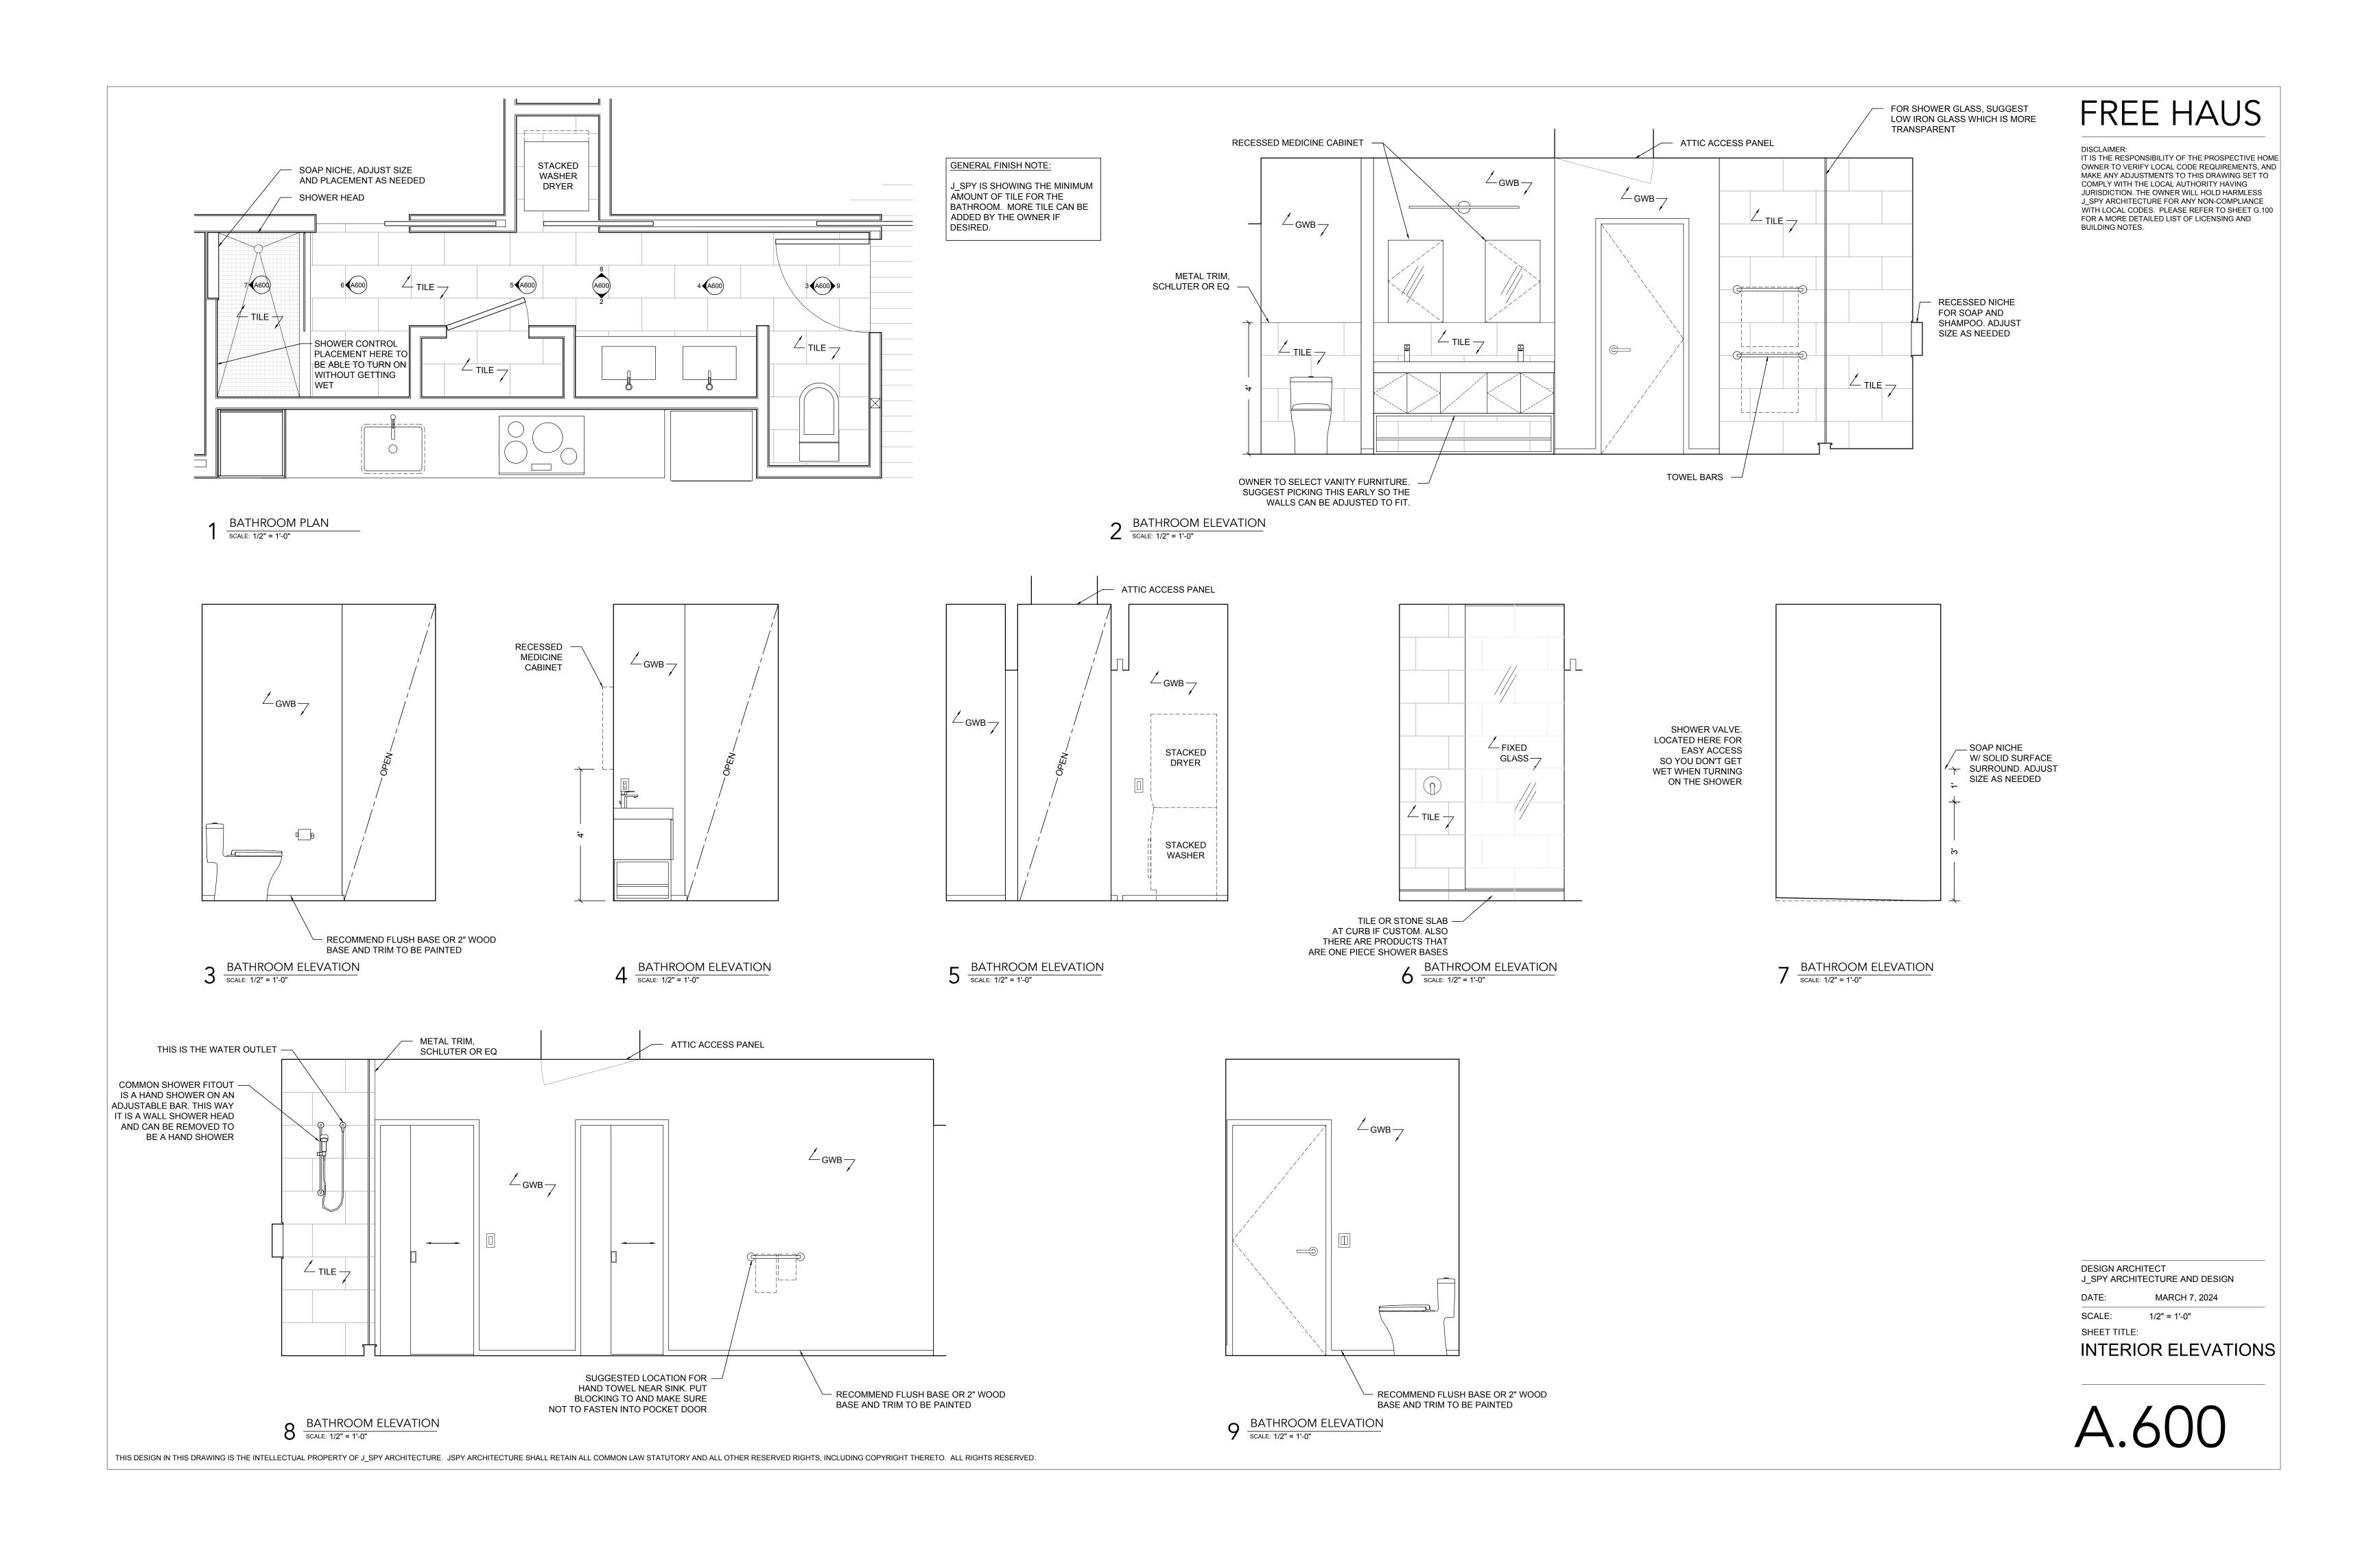
DESIGN ARCHITECT
J_SPY ARCHITECTURE AND DESIGN

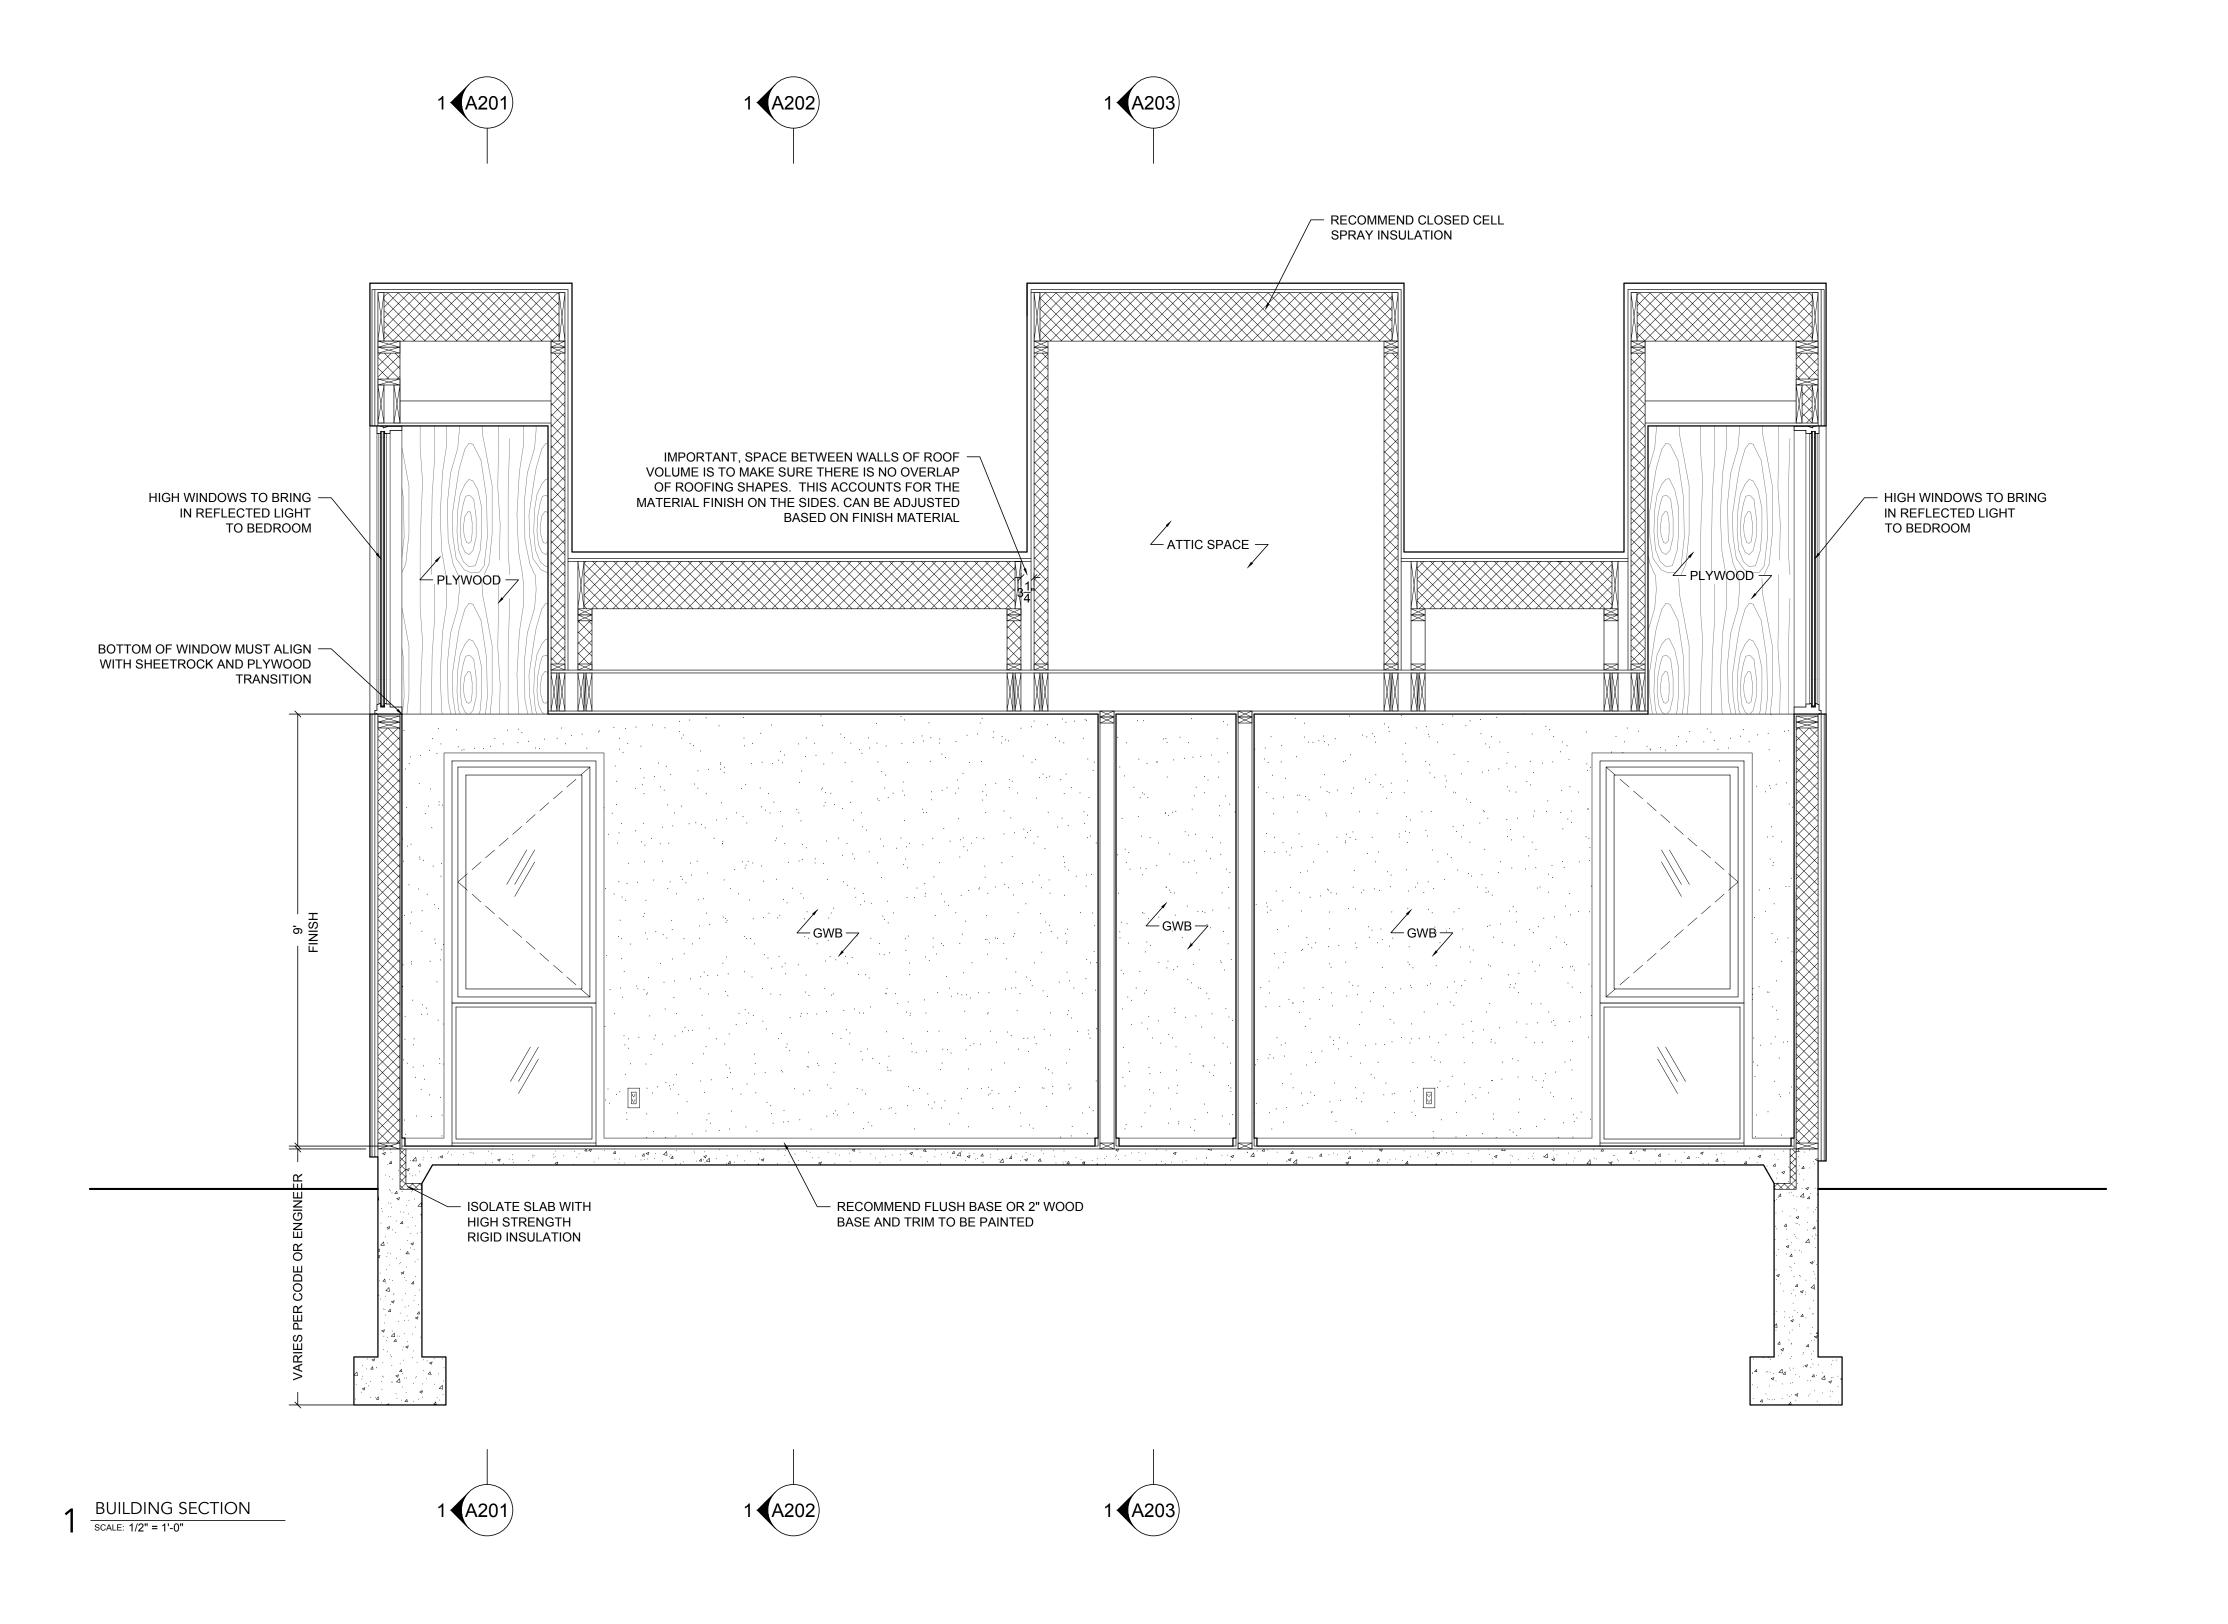DATE: MARCH 7, 2024


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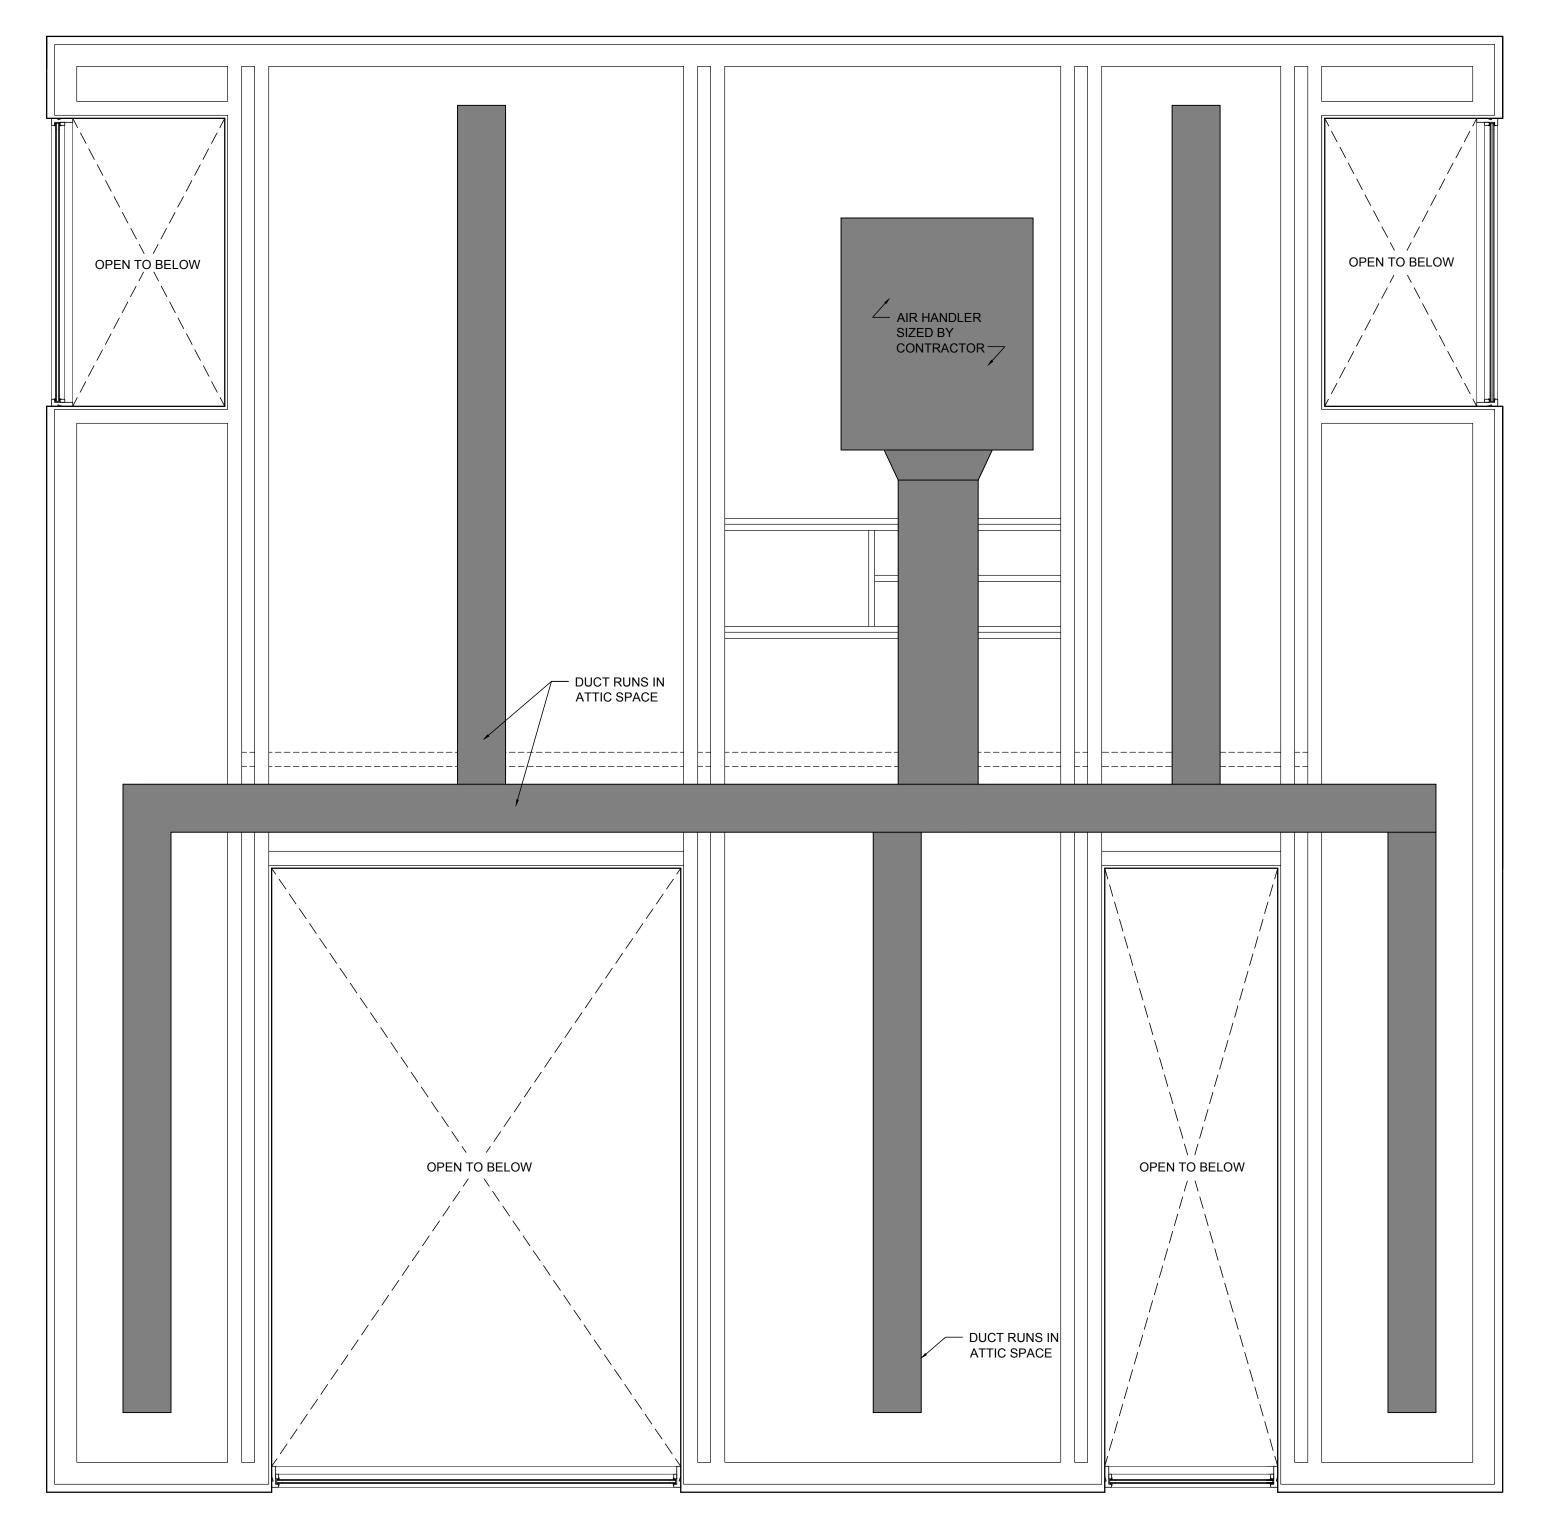
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SHEET TITLE:

BUILDING SECTION



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NOTES ON THE MECHANICAL SYSTEM

- 1. THE RECOMMENDED HEATING AND COOLING SYSTEM IS A "SPLIT SYSTEM" OR A HEAT PUMP LOCATED AT THE EXTERIOR AND CONNECTED TO AN INTERIOR AIR HANDLER AND DUCT SYSTEM. THIS IS ECONOMICAL BECAUSE THE HEAT PUMP CAN BOTH HEAT AND COOL DEPENDING ON THE SEASON. SO HEATING AND COOLING WILL BE BY THE DUCT SYSTEM. THESE UNITS ARE ELECTRIC AND DON'T REQUIRE BURNING OF FOSSIL FUELS.
- 2. IF YOU ARE CONSIDERING A HEATED FLOOR, THAT IS MORE COMPLICATED. MOST HEATED FLOORS USE A WATER BASED SYSTEM, SO YOU NEED SOMETHING TO HEAT THE WATER. TYPICALLY THIS IS A BOILER, BUT IT REQUIRES MORE SPACE THAN ALLOTTED IN THIS DESIGN. YOU WOULD PROBABLY HAVE TO ADJUST THE LAYOUT TO FIT THE BOILER. ANOTHER WAY TO HEAT WATER IS A GEOTHERMAL HEAT PUMP. THAT IS MORE ENERGY EFFICIENT AND DOESN'T BURN ANY FOSSIL FUELS, BUT AGAIN REQUIRES A UNIT THE SIZE OF A BOILER WHICH WOULD BE DIFFICULT TO FIT IN THIS DESIGN.
- 3. THE HOT WATER HEATER IS ASSUMED TO BE A PROPANE OR GAS POWERED TANKLESS UNIT IN THE CLOSET IN THE BATHROOM.
- 4. IF THE HOUSE IF VERY WELL INSULATED, YOU MIGHT NEED A FRESH AIR SUPPLY SYSTEM, OR HRV OR ERV. THAT SHOULD FIT IN THE ATTIC SPACE. TALK TO YOUR CONTRACTOR ABOUT THIS OPTION.
- 5. IN THE DUCTED DESIGN AS SHOWN, THERE WILL BE GRILLS IN THE PLYWOOD CEILING. CONSIDER USING "LINEAR BAR GRILLS" FOR THESE LOCATIONS AS THEY WILL BE VISIBLE.

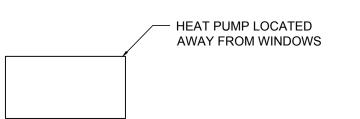DESIGN ARCHITECT
J_SPY ARCHITECTURE AND DESIGN

DATE: MARCH 7, 2024

SCALE: 1/2" = 1'-0"
SHEET TITLE:

MECHANICAL DIAGRAM